


SYMBOL LIST

	VOLUME DAMPER
	ACOUSTIC LINED DUCT
	FLEXIBLE CONNECTOR IN DUCT
	AUTOMATIC TEMPERATURE CONTROL/CENTER
	SUPPLY REGISTER
	RETURN GRILLE
	RETURN REGISTER
	CONDENSATE DRAIN LINE
	SUPPLY REGISTER INSTALLED IN 4" METAL COLLAR

NOTES
1. REFER TO NOTES ON DRAWING NO. AC-6

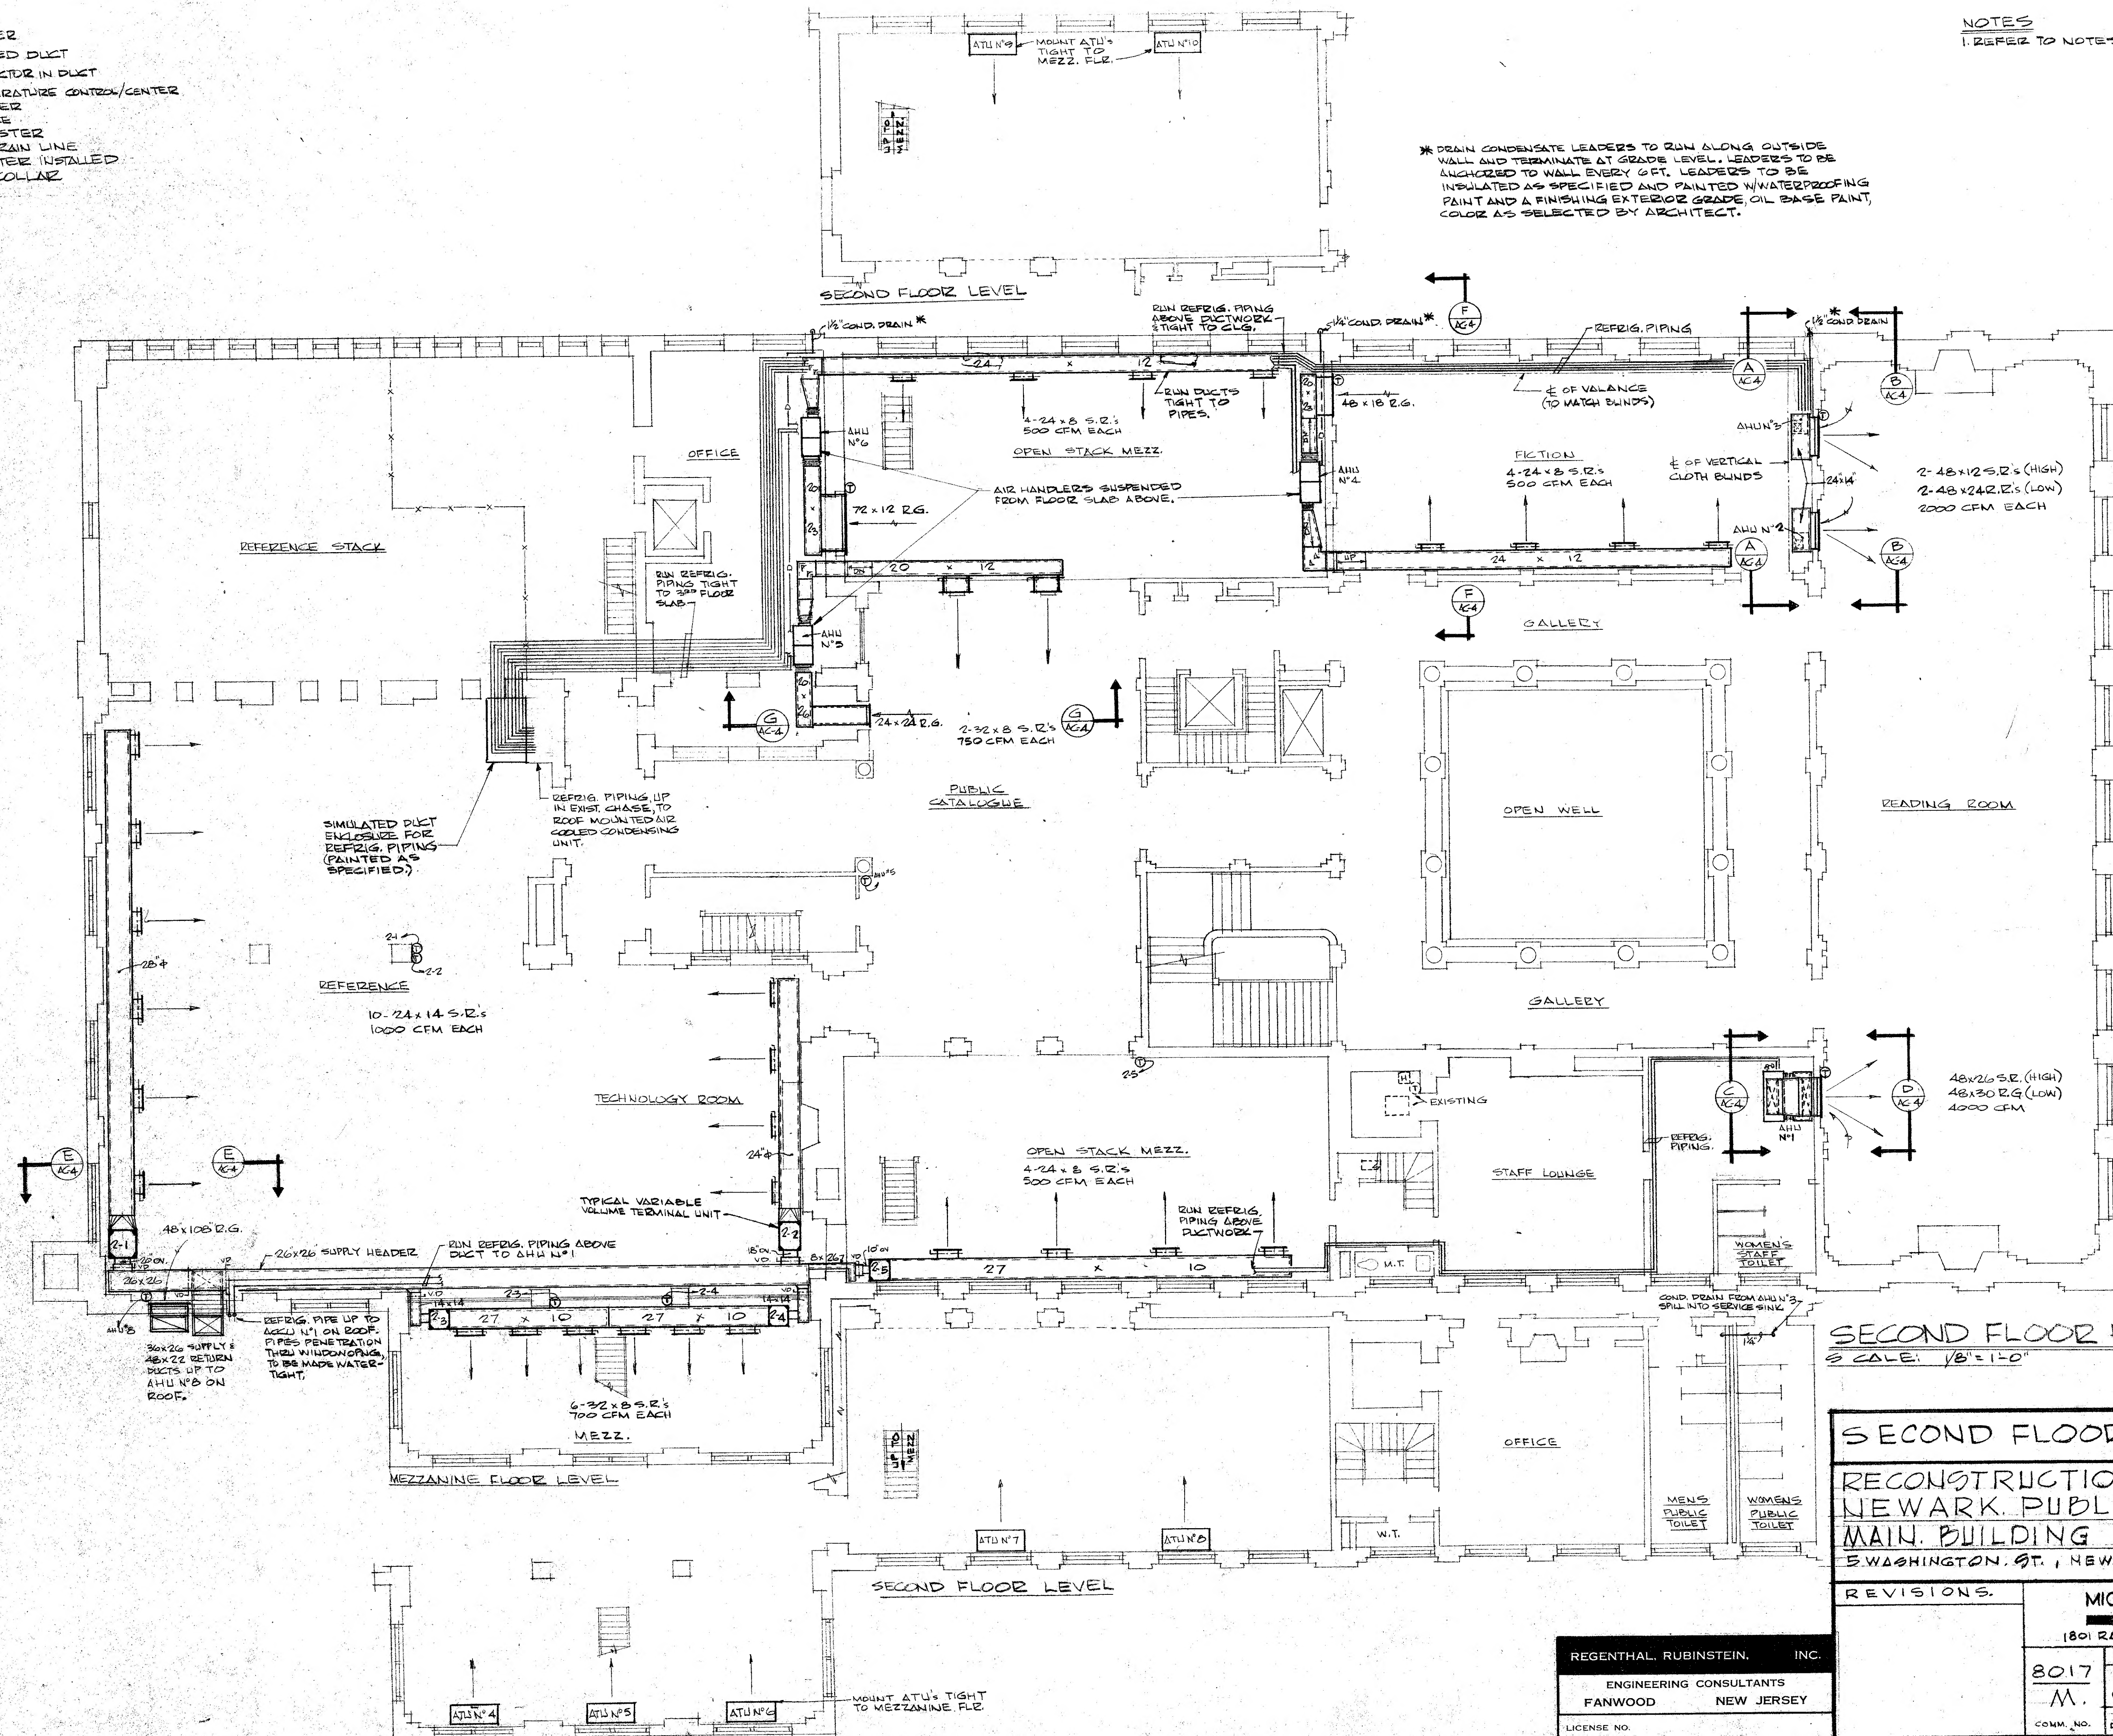

SECOND FLOOR PLAN
SCALE: 1/8" = 1'-0"

SECOND FLOOR PLAN
RECONSTRUCTION OF THE
NEWARK PUBLIC LIBRARY
MAIN BUILDING
5 WASHINGTON ST., NEWARK, N.J.

REVISIONS.		MICHAEL A. TROTTA ARCHITECT 1801 RAVINE DR., FORKED RIVER, N.J.	
8017	609/693-3392		
M.	CERT. NO. C-2948		
COMM. NO.	DATE 4/5/82	SCALE AS NOTED	DWG. NO.

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LICENSE NO.

NEWARK LIBRARY


THIRD FLOOR PLAN
SCALE: 1/8" = 1'-0"

THIRD FLOOR
RECONSTRUCTION
NEWARK PUBLIC
MAIN BUILDING
5 WASHINGTON ST. N.J.


REVISIONS

THIRD FLOOR PLAN
RECONSTRUCTION OF THE
NEWARK PUBLIC LIBRARY
MAIN BUILDING
5 WASHINGTON ST., NEWARK, N. J.


REGENTHAL, RUBINSTEIN,	INC.
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FANWOOD	NEW JERSEY
LICENSE NO.	

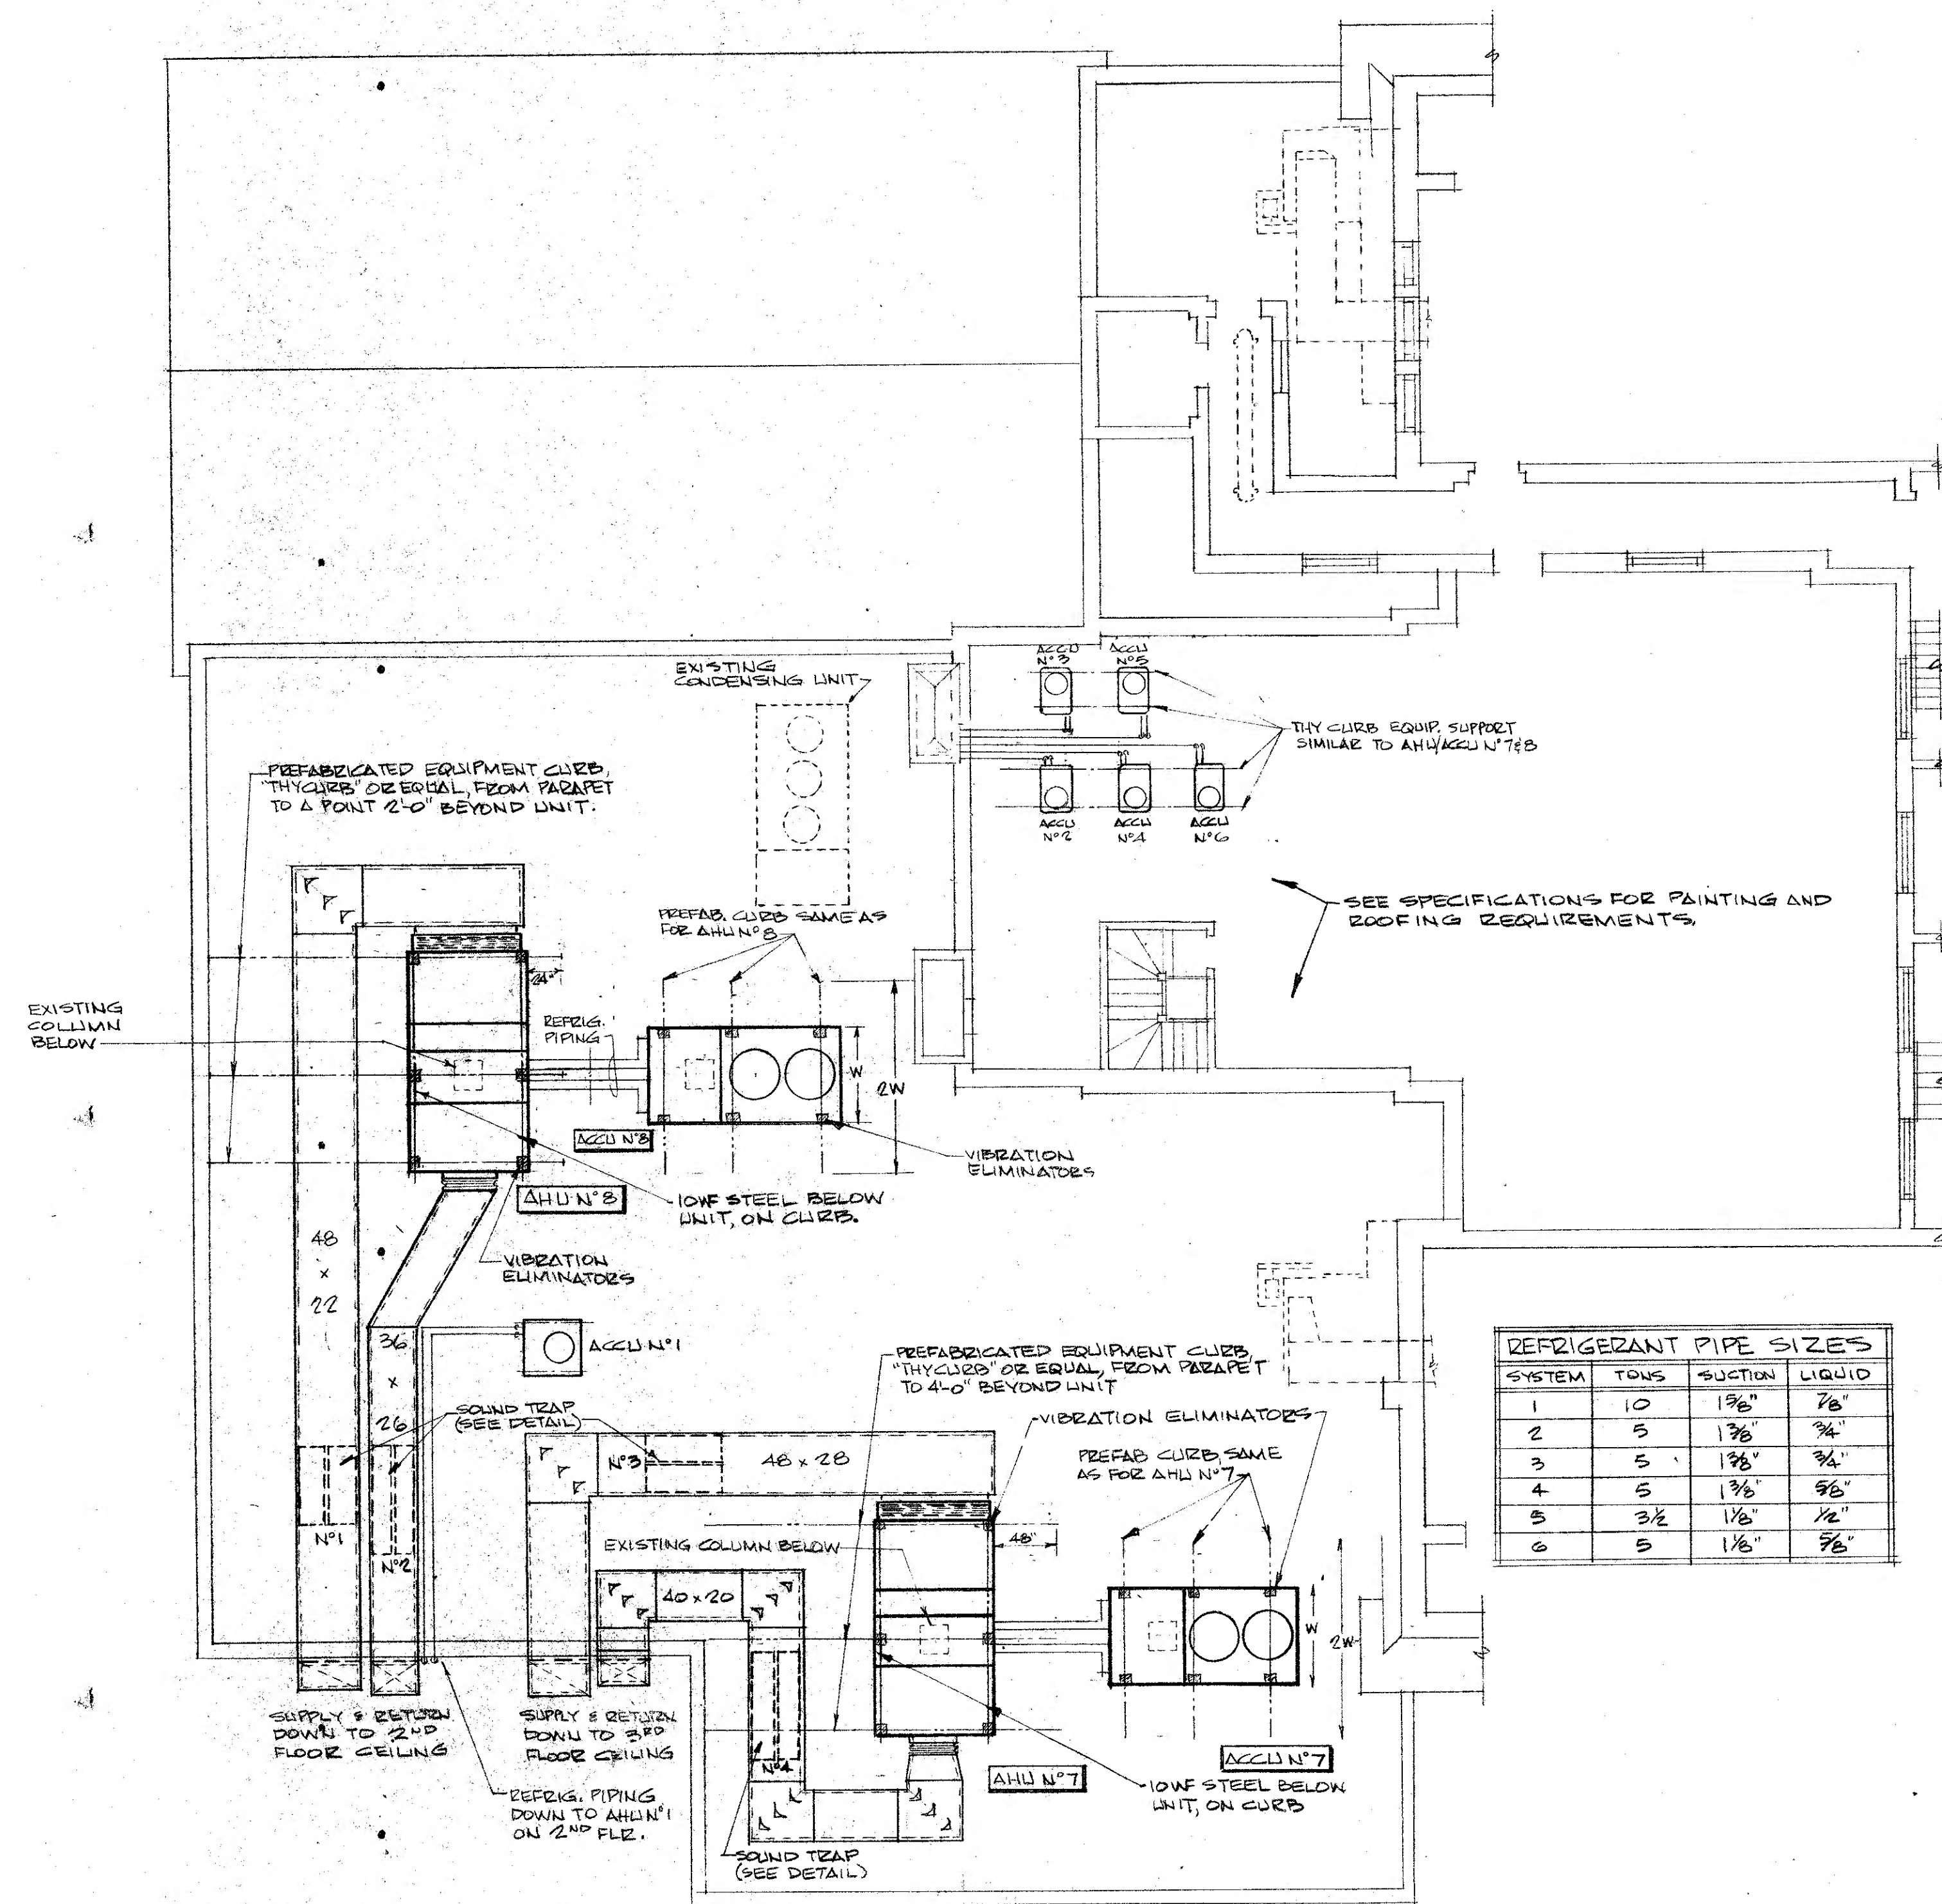

TYPICAL END ELEVATION of AHU N° 7 or 8
not to scale

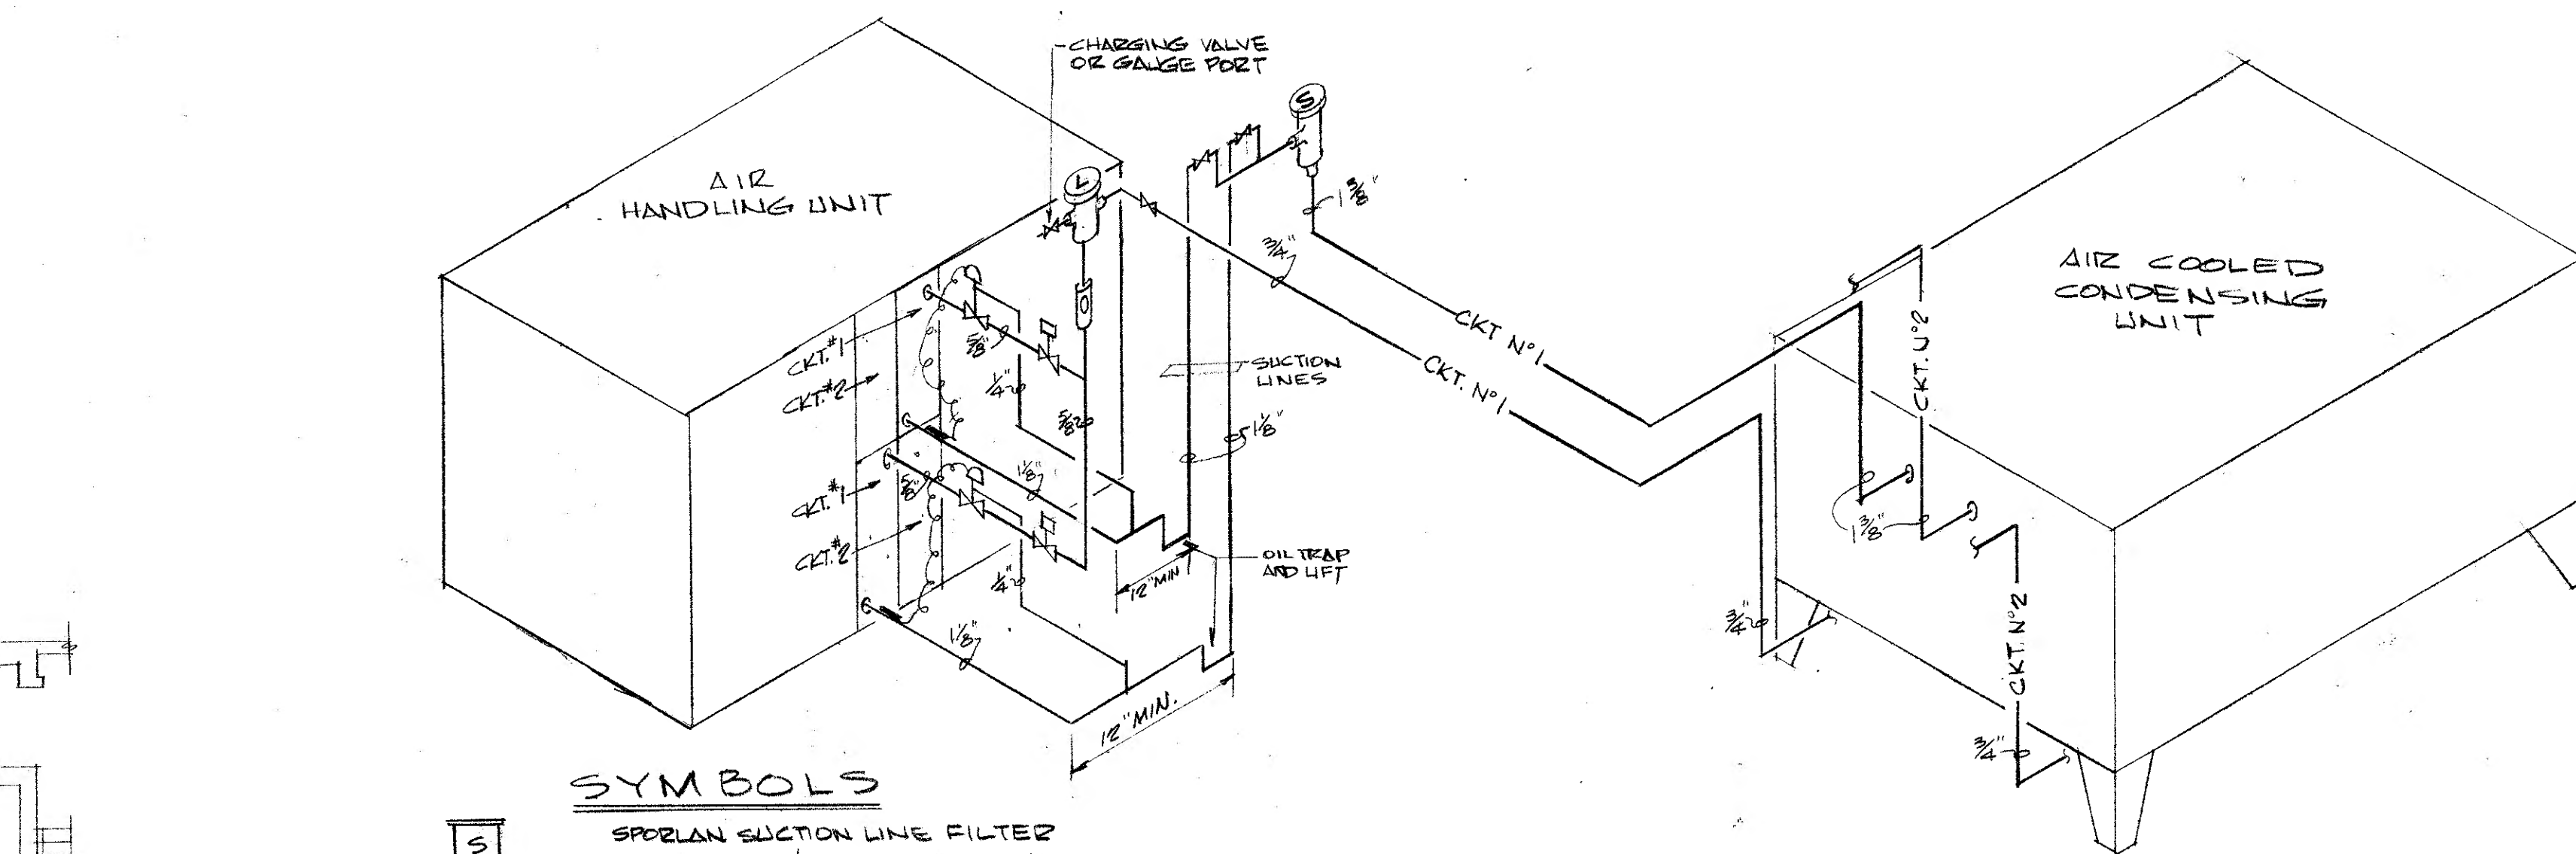


SYMBOLS

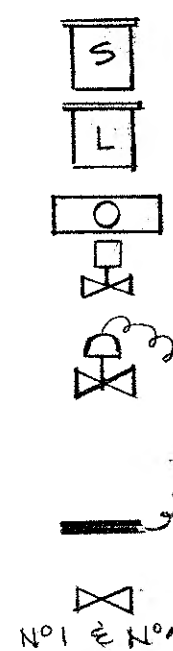

SPORLAN SUCTION LINE FILTER
TYPE SF W/ACCESS VALVE
SPORLAN LIQUID LINE FILTER/DRIER
TYPE C W/1/4" CHARGING PORT
SPORLAN TYPE S4 SIGHT GLASS -
MOISTURE INDICATE
3/4" SOLENOID VALVE
SPORLAN TYPE OVE THERMOSTATIC
EXPANSION VALVE W/BALANCE COIL
SIZED FOR VA.V. SYSTEM BY COIL
MFR. TO SUIT DISTRIBUTOR CAPACITY,
TWX SENSING ELEMENT DIRECT CONTACT
TIGHTLY SECURED TO SUCTION BRANCH
AT 4 OR 8 O'CLOCK POSITIONS.
REFRIGERANT SHUT-OFF VALVE
REFRIG. PIPING CONNECTED TO ACCU CIRCUITS


NOTE: PIPING VALVES, ETC. TYPICAL FOR TWO (2) CIRCUITS.

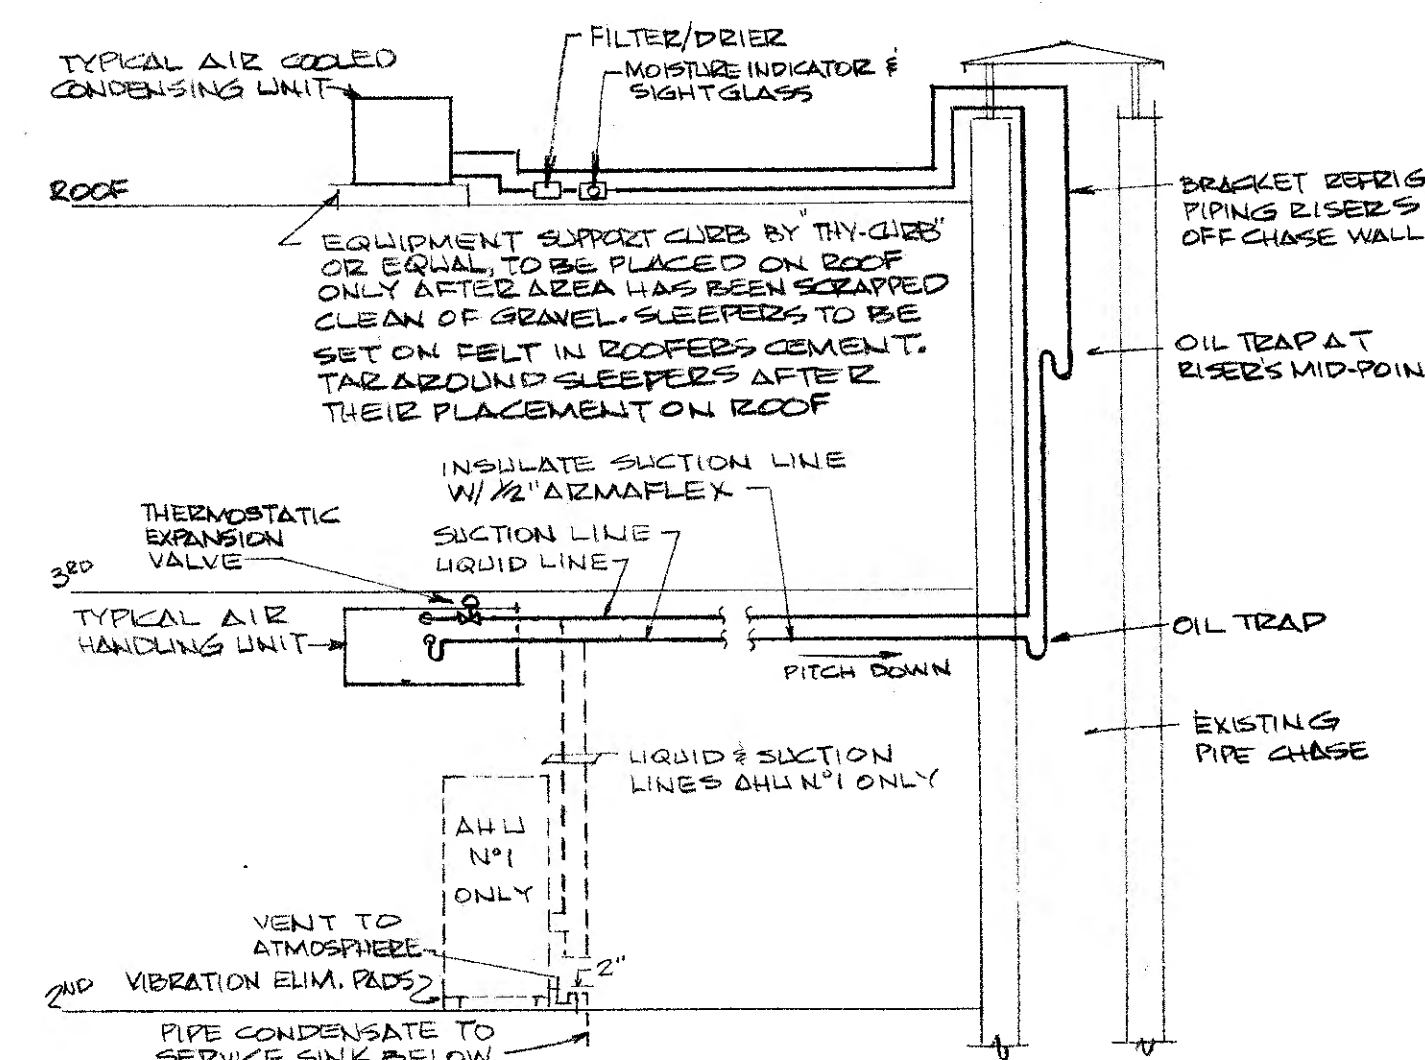

REFRIGERANT PIPING NOTES

1. REFRIGERANT PIPING TO BE SIZED IN ACCORDANCE WITH UNIT MFR'S. RECOMMENDATIONS AND PIPING INSTALLATION DRAWINGS TO BE SUBMITTED TO ENGINEER FOR APPROVAL.
2. LIQUID LINES CONNECTED TO DX COILS WITH EXPANSION VALVES, SIGHT GLASS/MOISTURE INDICATORS AND FILTER/DRIERS.
3. ALL AHU'S WITH TRAPPED AND VENTED CONDENSATE DRAIN AND SUCTON LINE INSULATED. MOUNT ALL SUSPENDED UNITS AS HIGH AS POSSIBLE TO PROVIDE MAXIMUM CLEARANCE AND CONDENSATE DRAIN PITCH.
4. INSTALL DRIP PANS UNDER EACH UNIT W/3" OVERLAP ON ALL SIDES. PANS 1/2" HIGH W/BOTTOM PITCHED TOWARDS CENTER. 3/4" DRAIN FITTING AT PAN CENTER TO BE CONNECTED TO COOLING COIL CONDENSATE DRAIN W/3/4" TRAPPED AND VENTED PIPE. ENTIRE PAN CONSTRUCTION TO BE MADE WATERPROOF AND EXTERNALLY INSULATED W/1/2" ARMAFLEX INSULATION.
5. ALL REFRIGERANT PIPING SHALL BE SUPPORTED WITH VIBRATION ABSORBERS. SYSTEMS N° 7 & 8 PIPING AS INDICATED ON DETAILS. PIPING RUNNING OVER DUCTS SHALL BE INDEPENDANTLY SUPPORTED FROM SLAB ABOVE.

SECTION THRU TYPICAL A.H.U.
not to scale

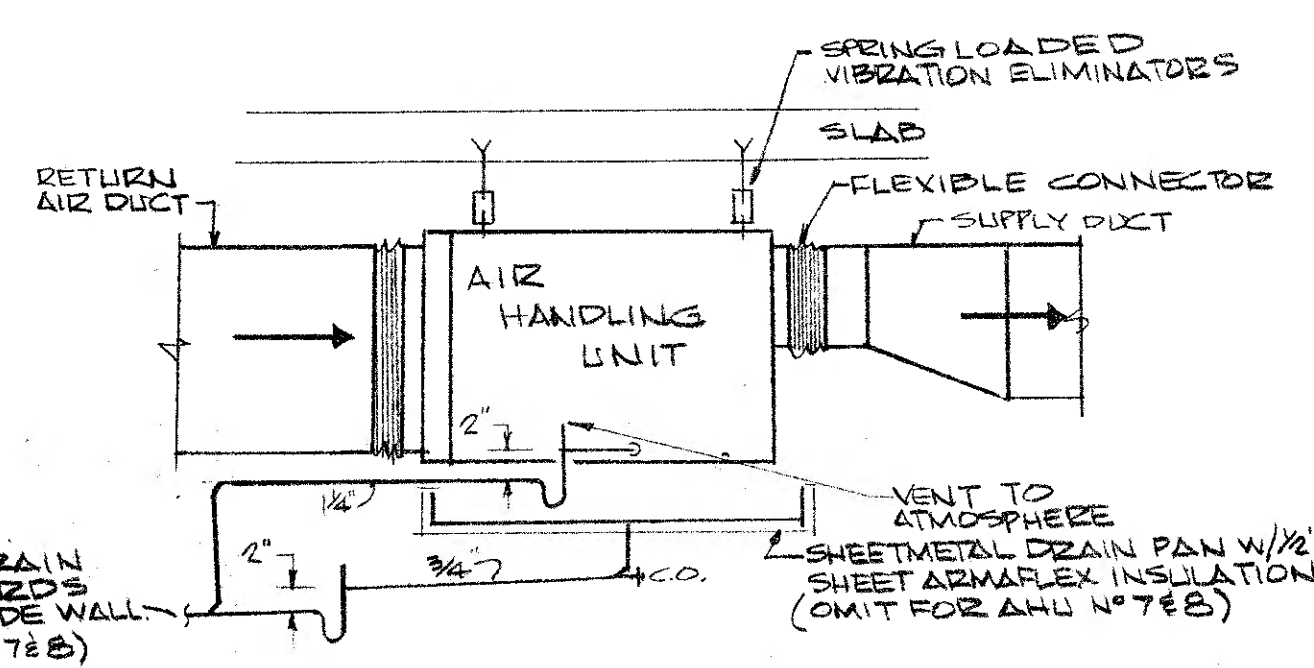

PARTIAL ROOF PLAN & DETAILS


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REVISIONS


MICHAEL A. TROTTA
ARCHITECT
1801 RAVINE DR. FORKED RIVER, N.J.

6017
M.
CERT. NO. C-2948
DATE 1/5/82
SCALE: AS NOTED
DEVS. NO.


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LICENSE NO.

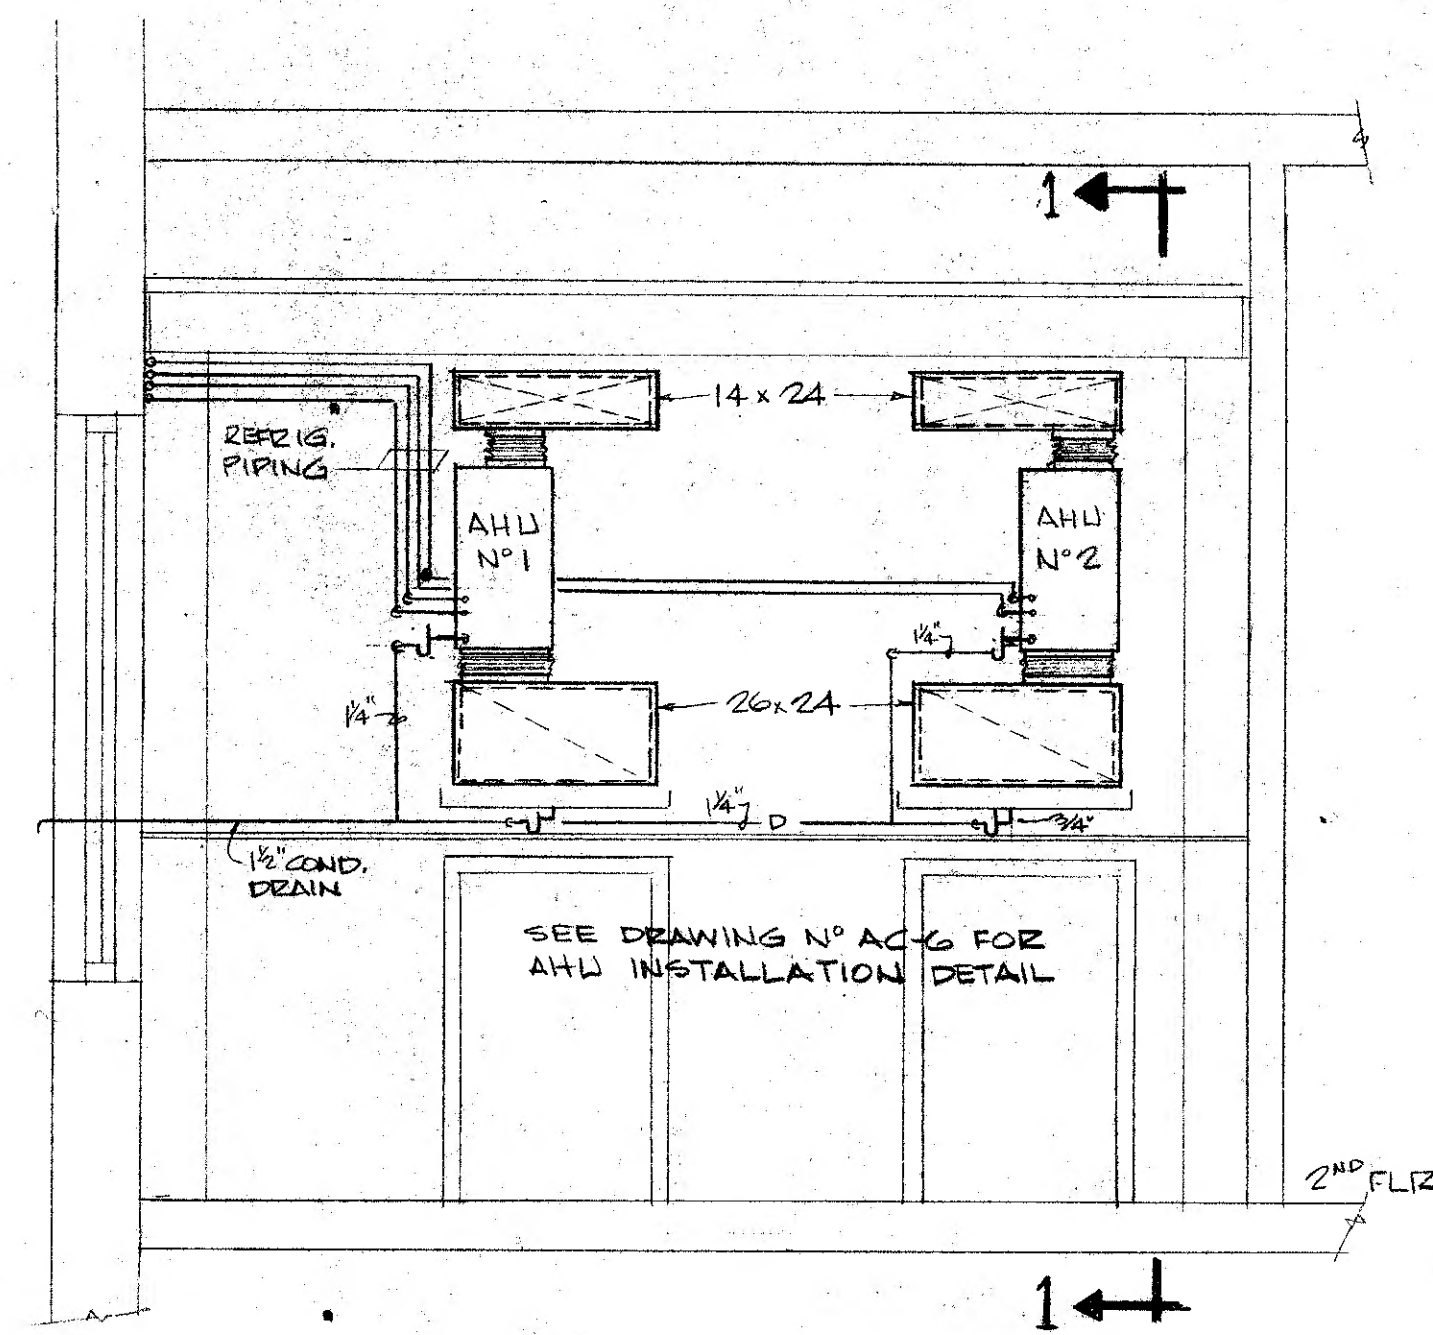


ELEVATION A-A
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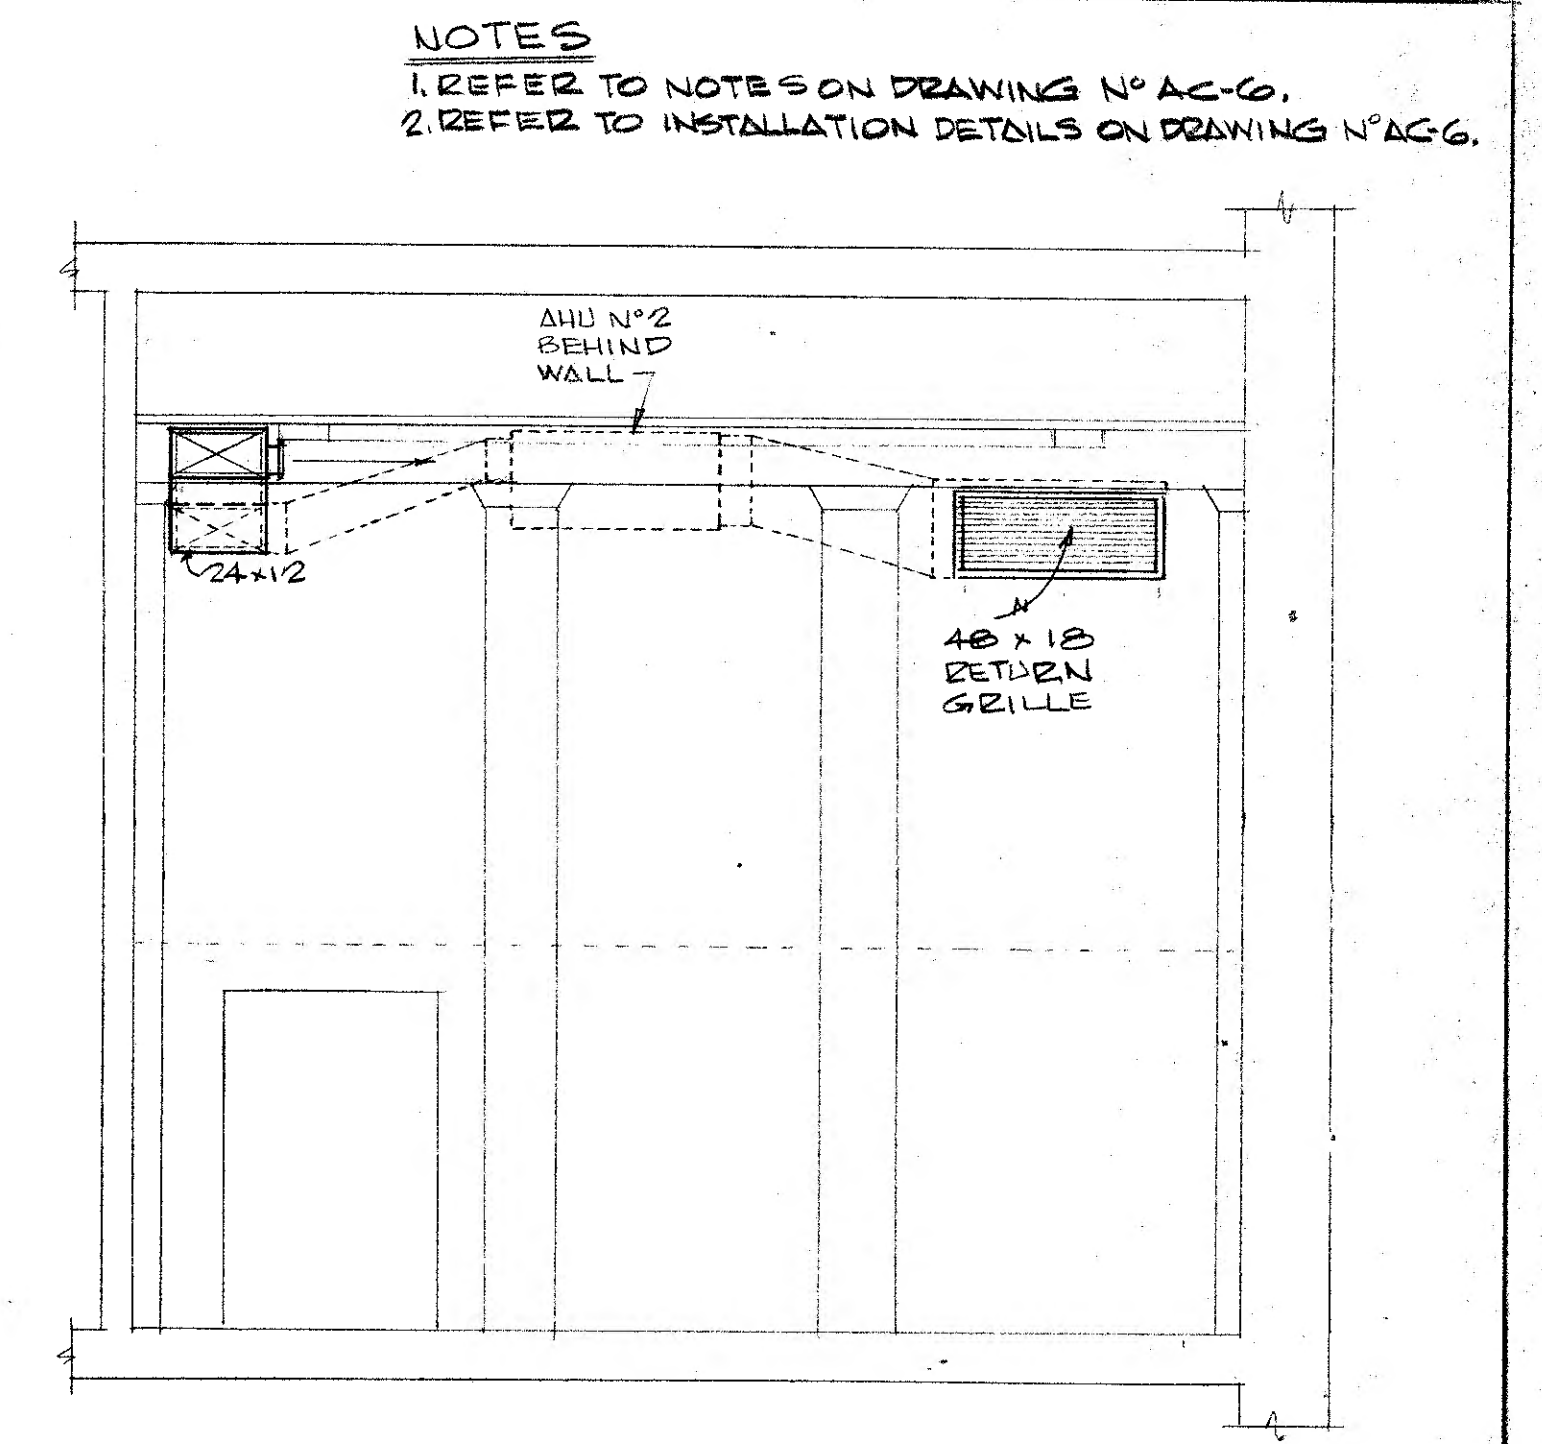
SECTION 1-1
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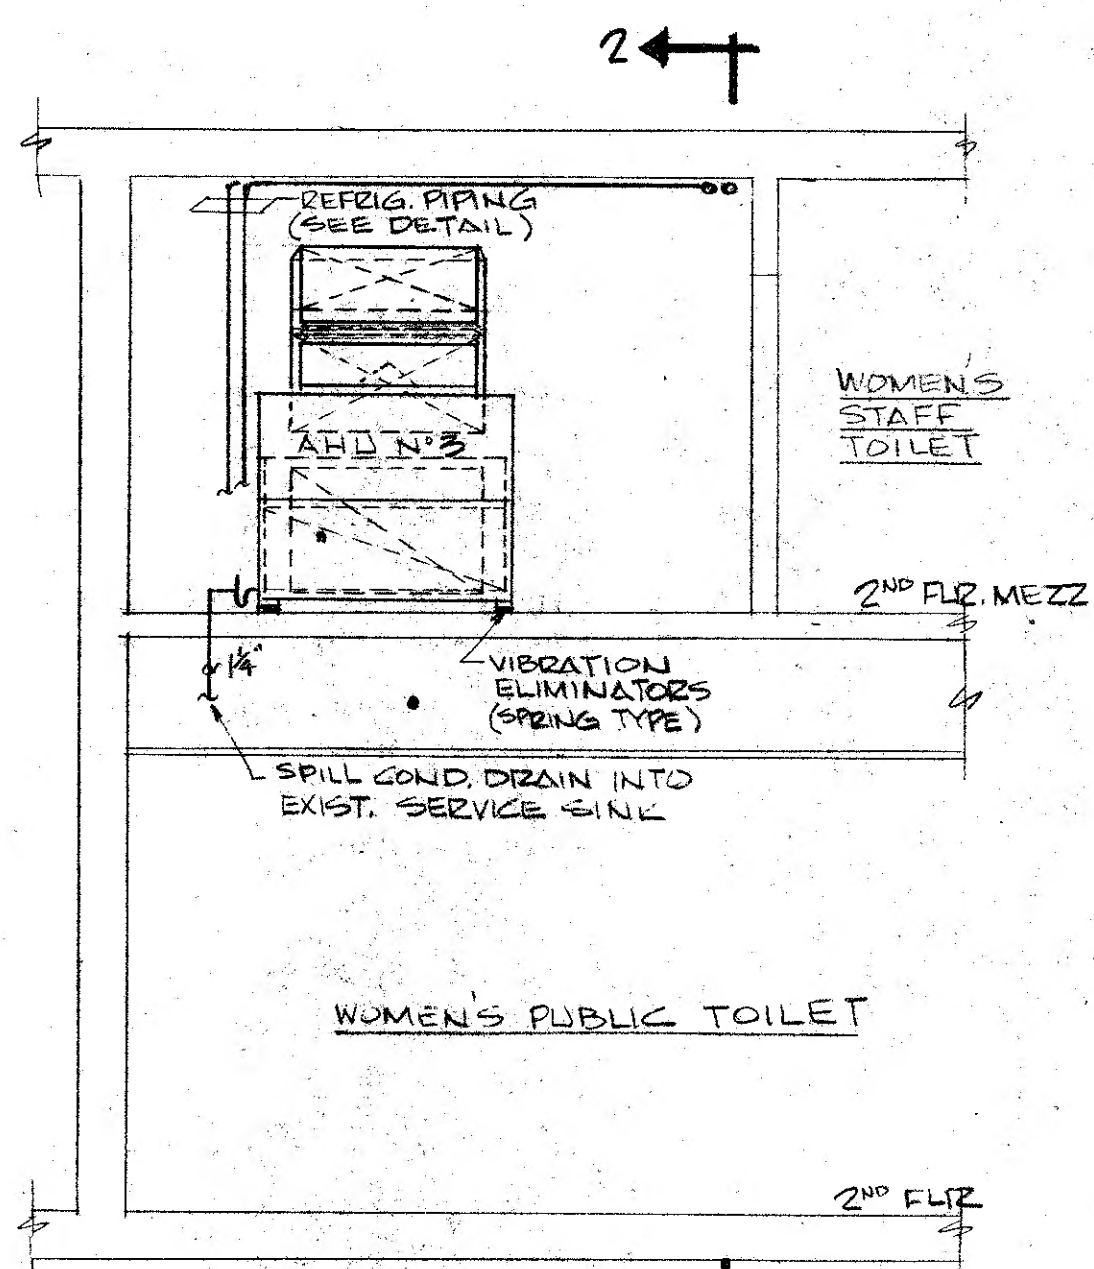
ELEVATION B-B
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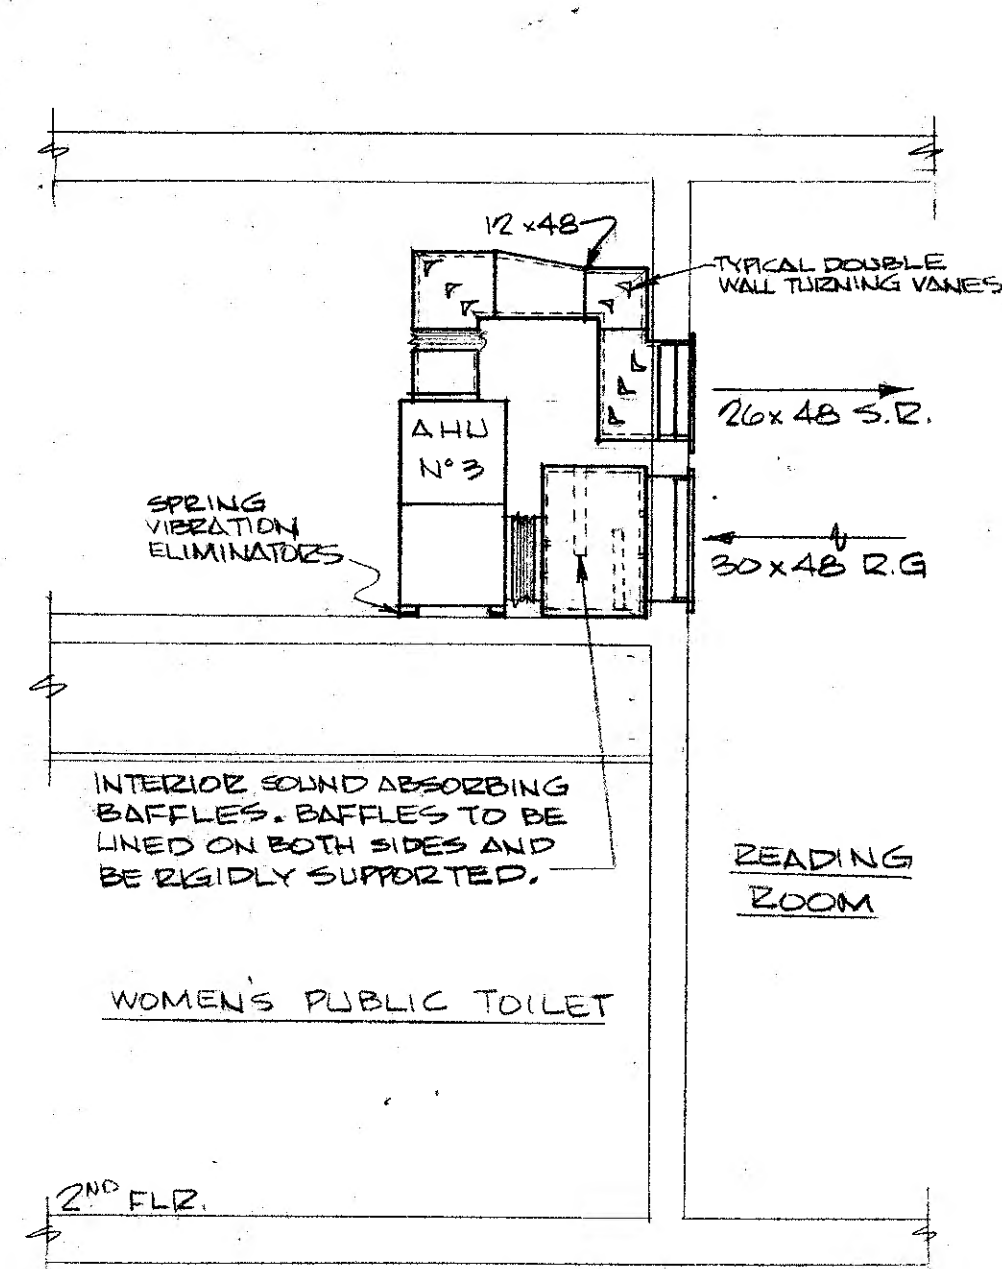
ELEVATION E-E
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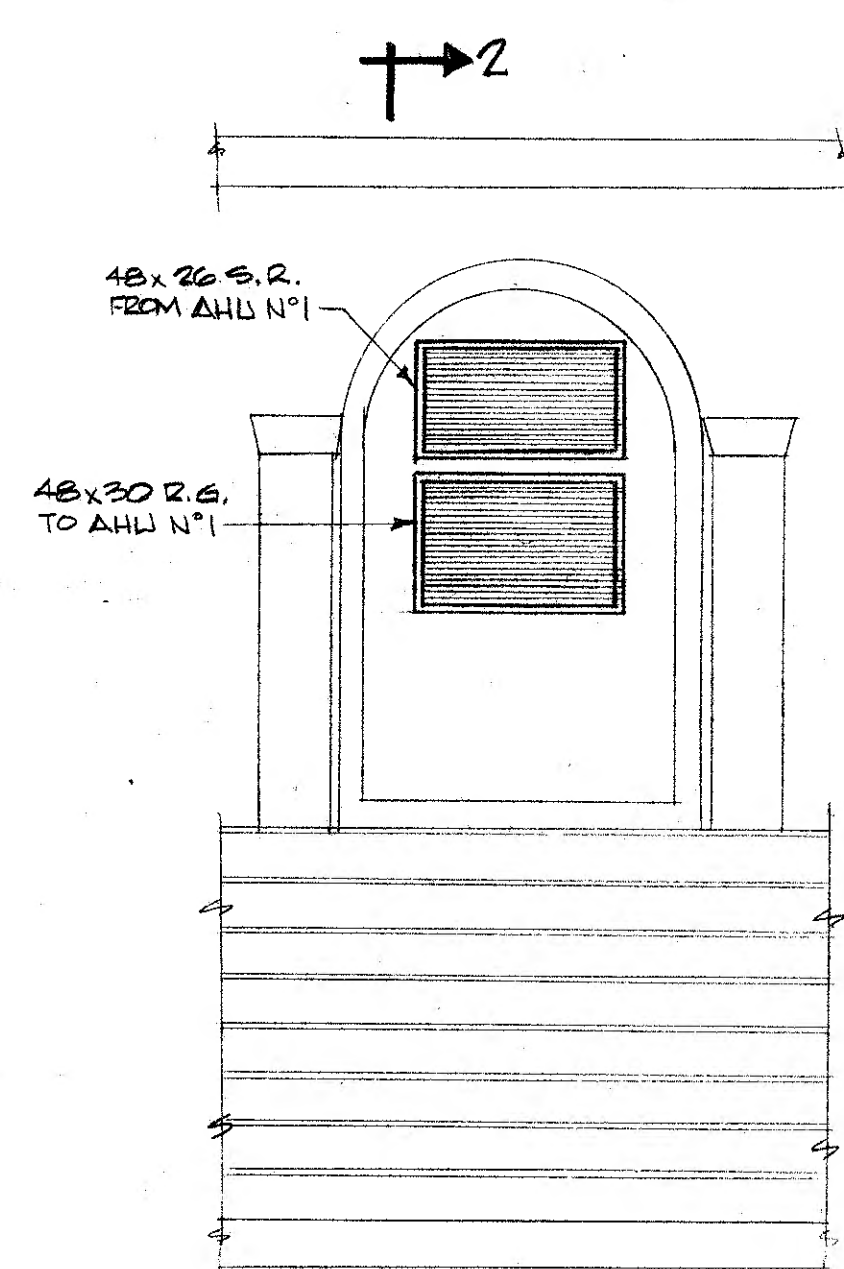
ELEVATION F-F
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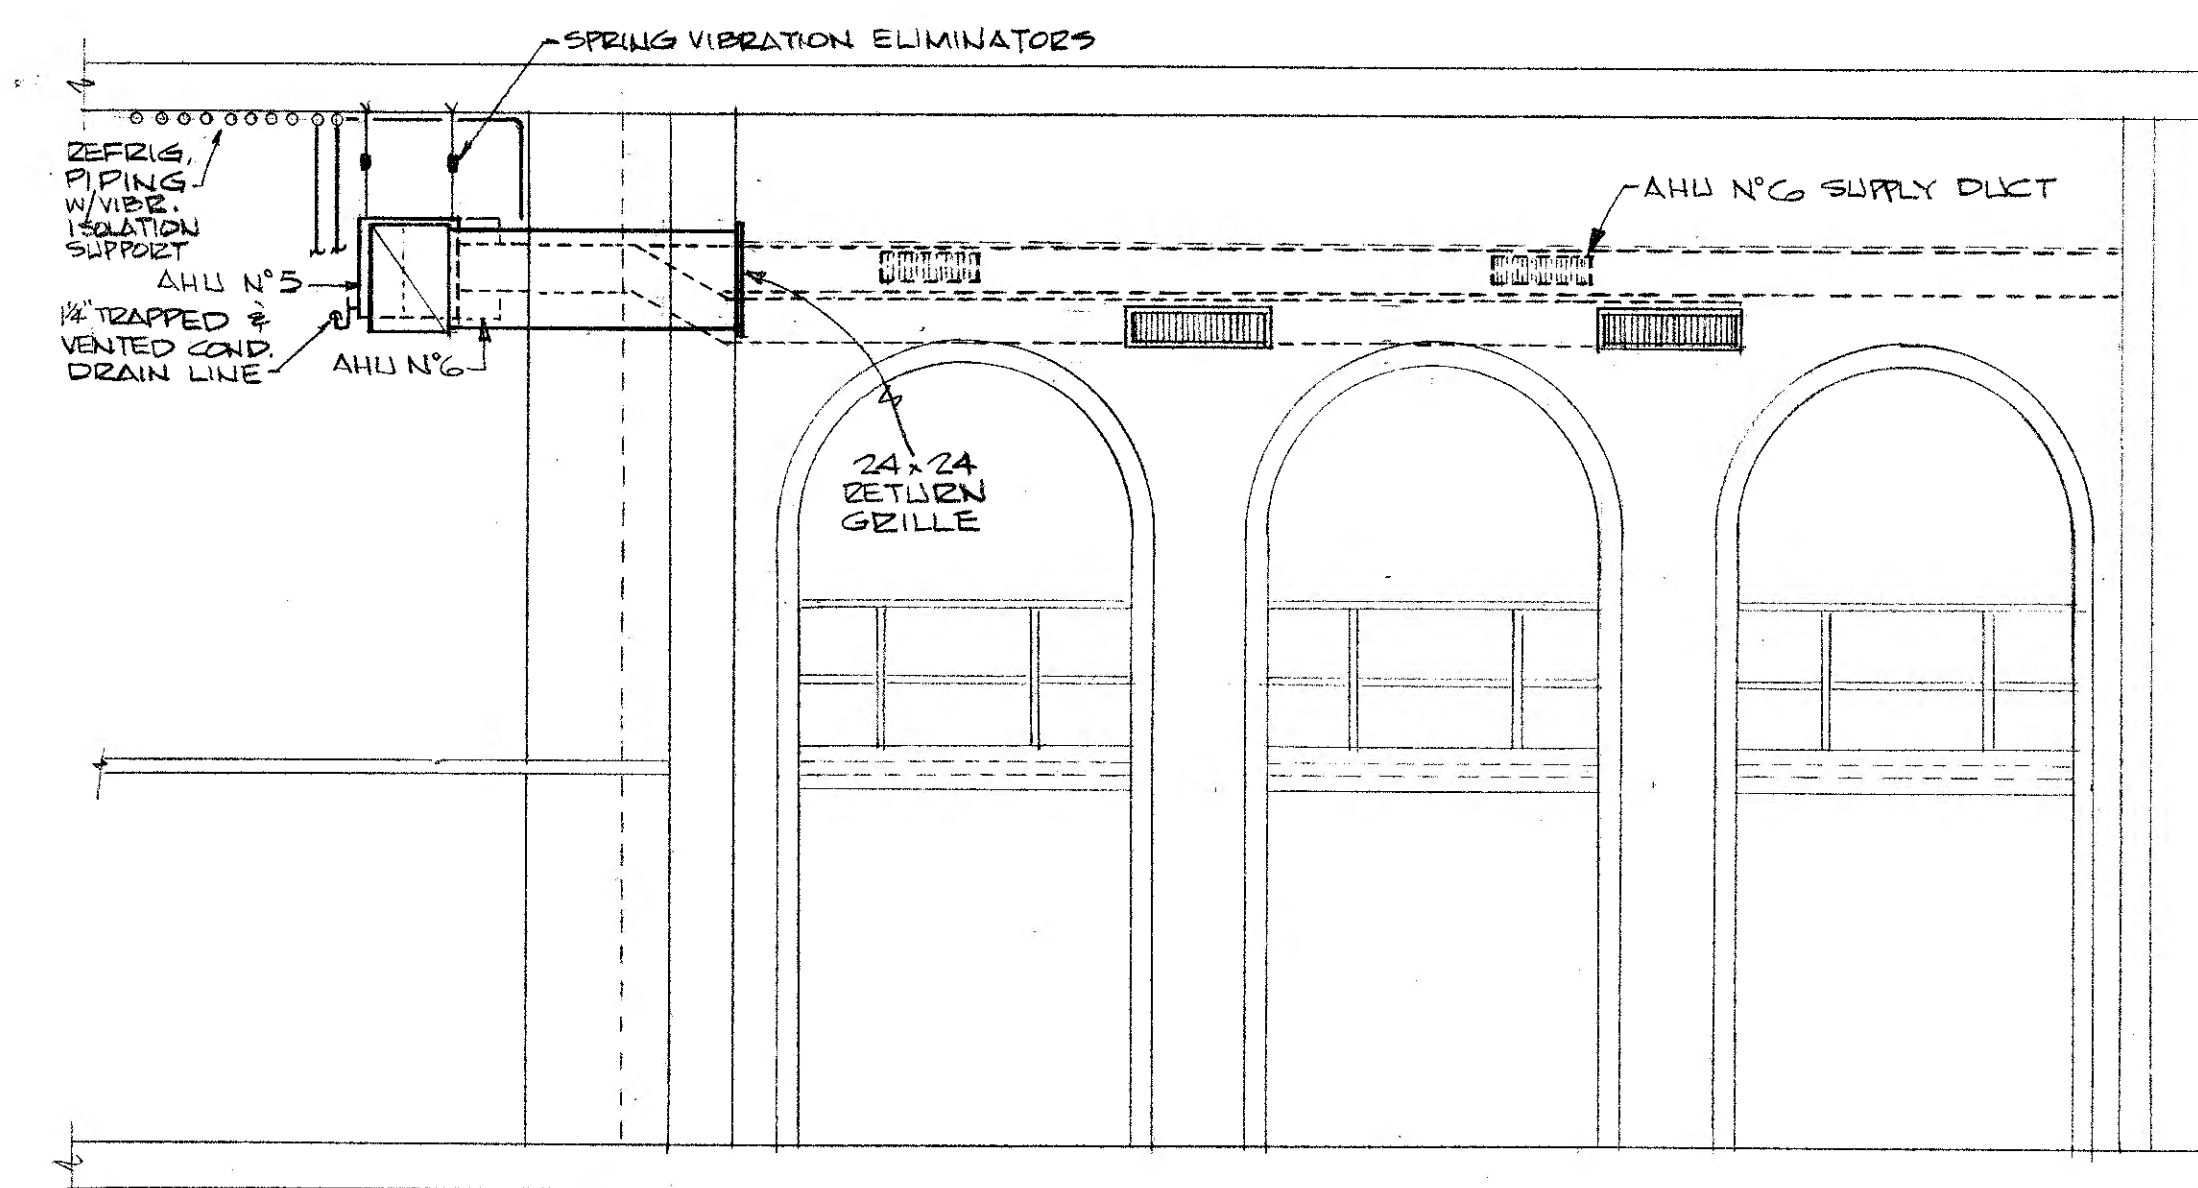
ELEVATION C-C
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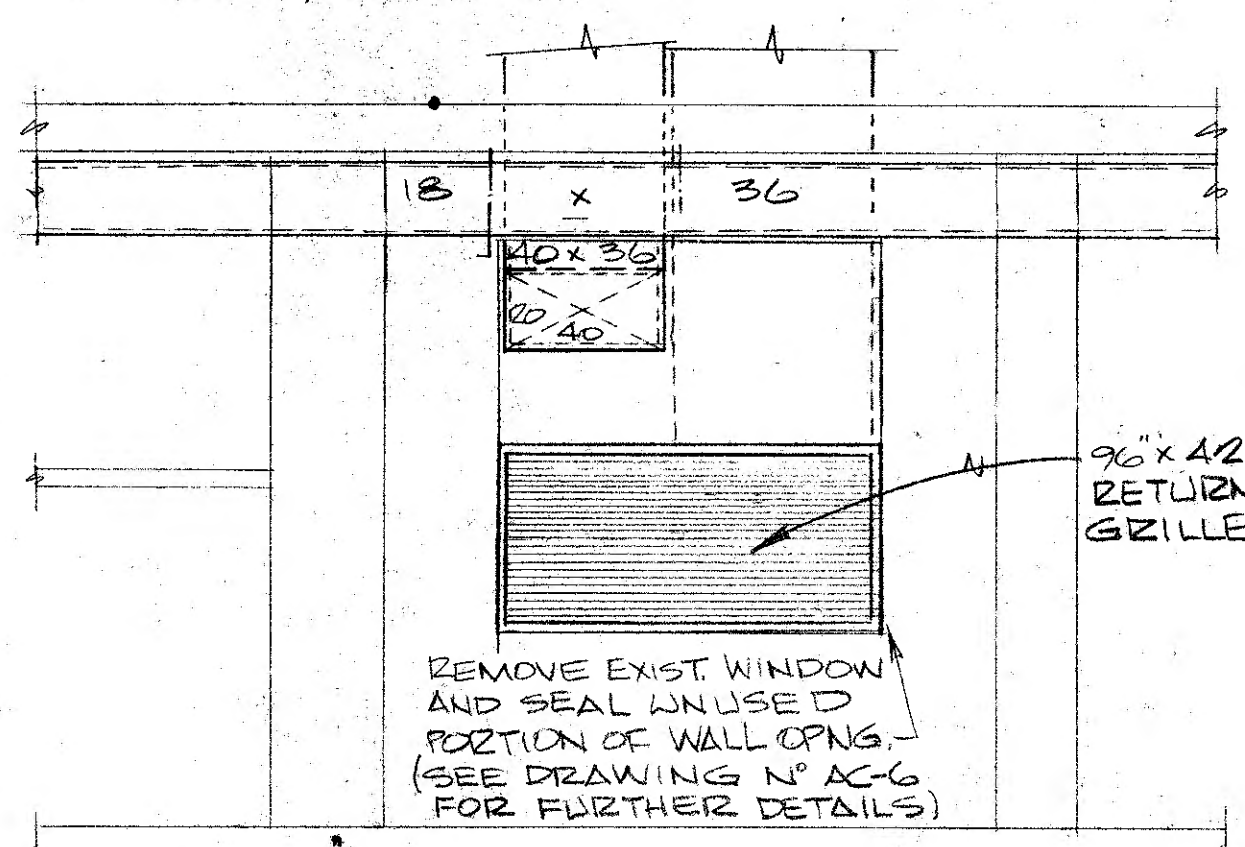
SECTION 2-2
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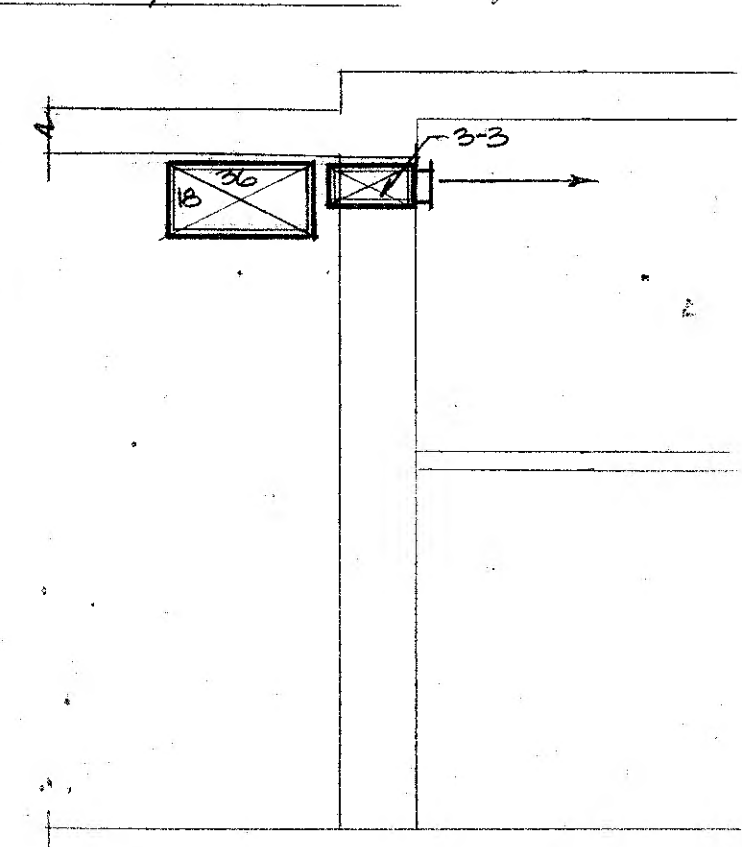
ELEVATION D-D
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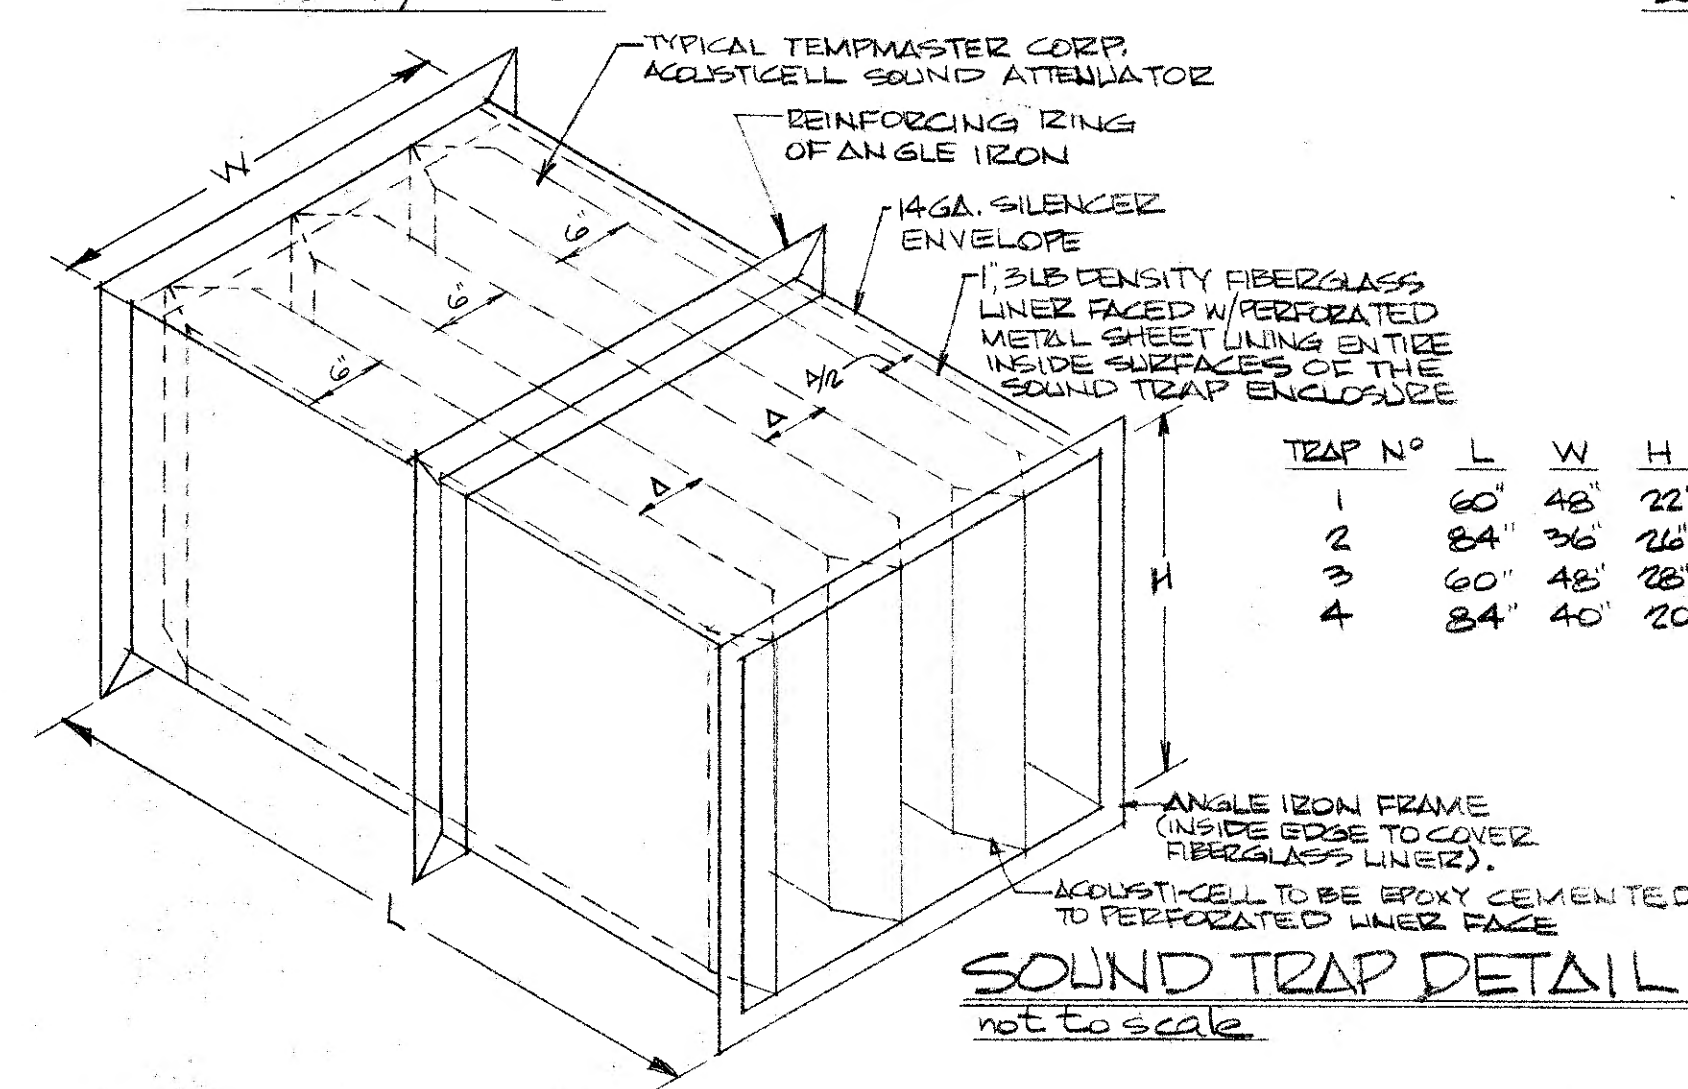
ELEVATION G-G
scale: 1/4" = 1'-0"

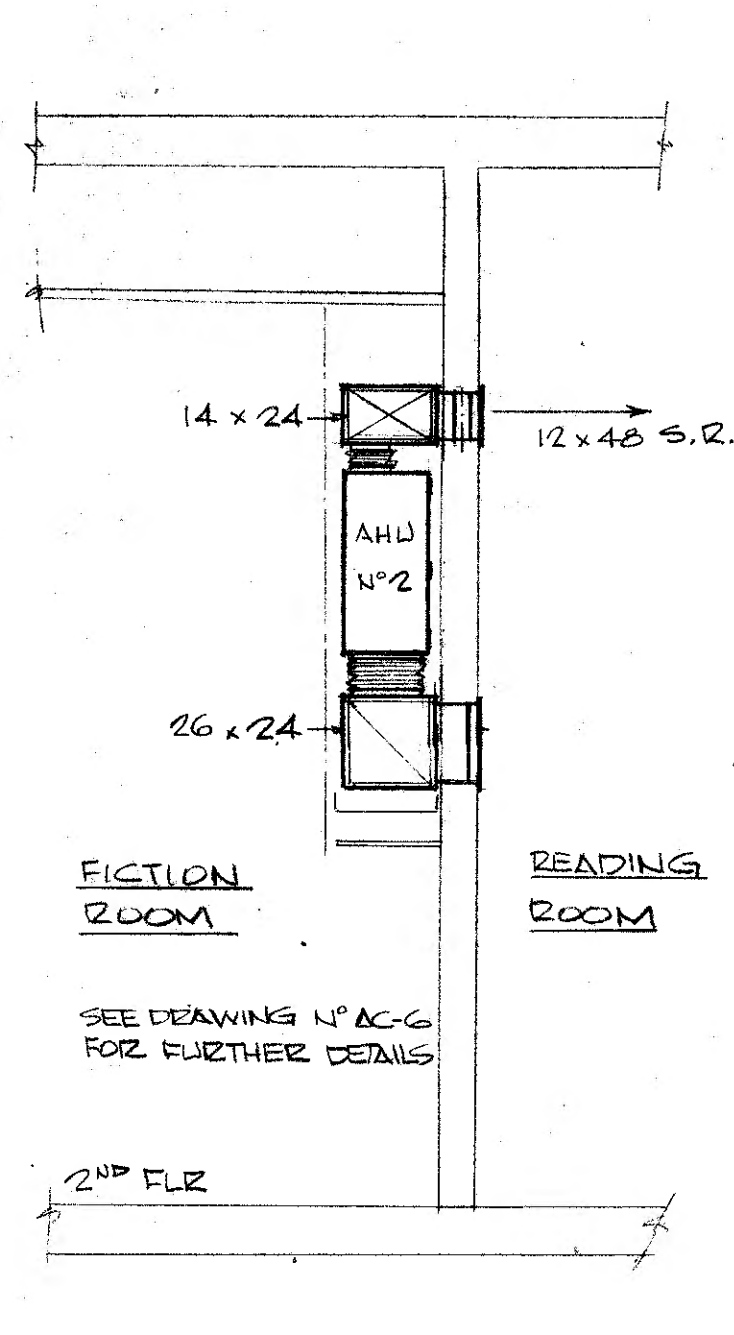

ELEVATION H-H
scale: 1/4" = 1'-0"

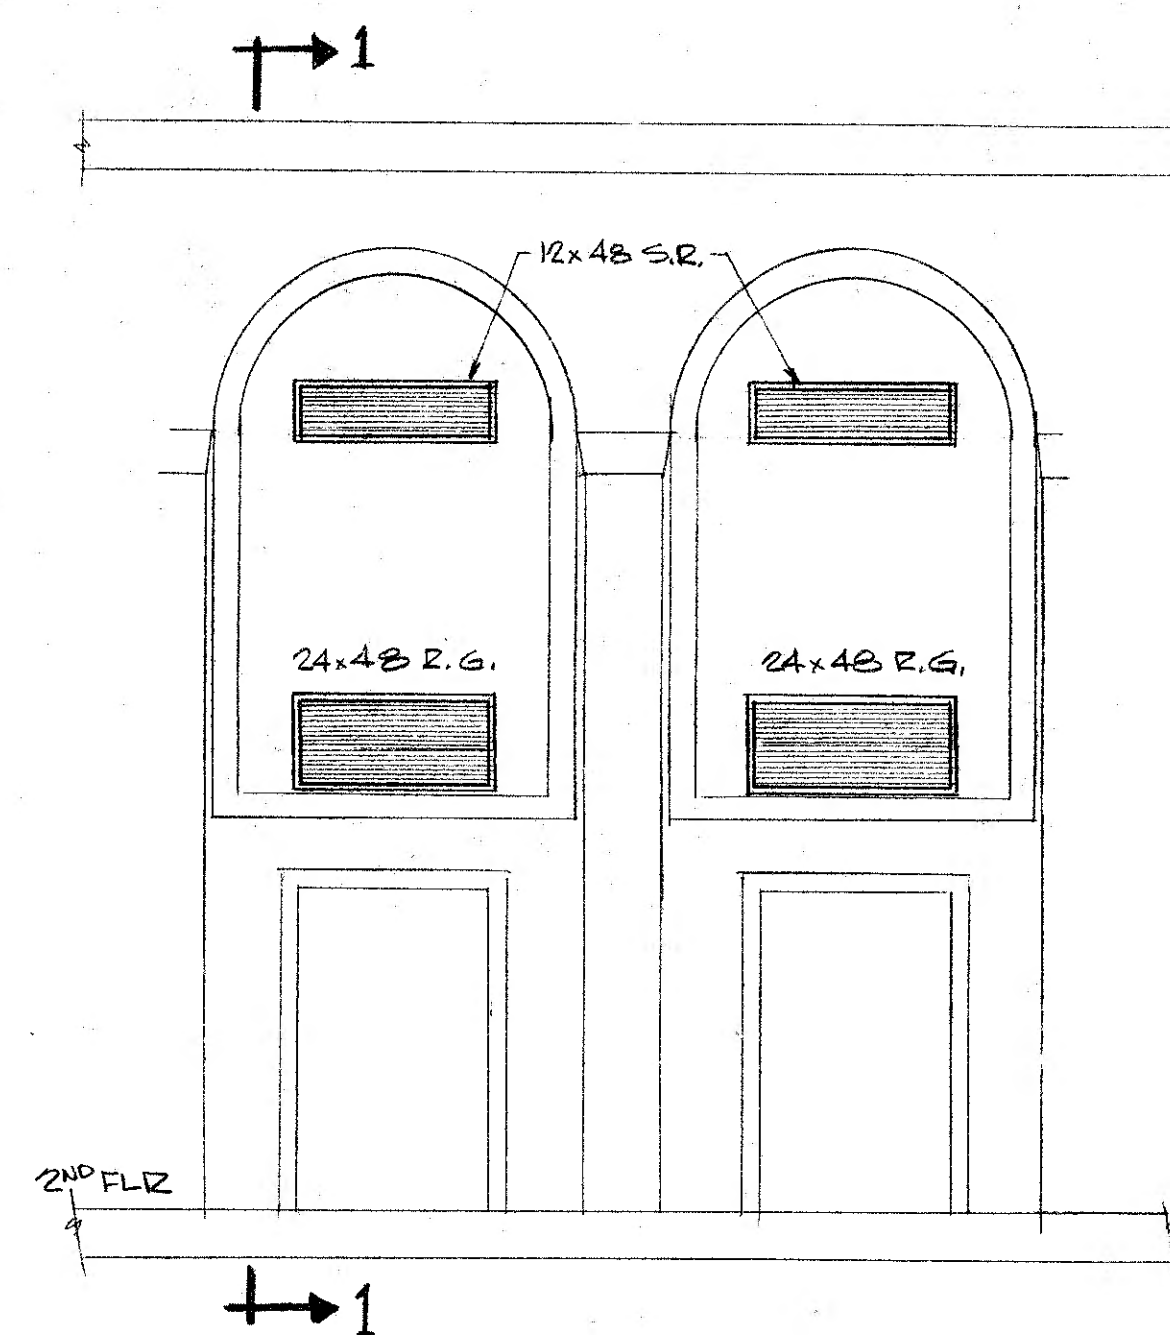

ELEVATION I-I
scale: 1/4" = 1'-0"

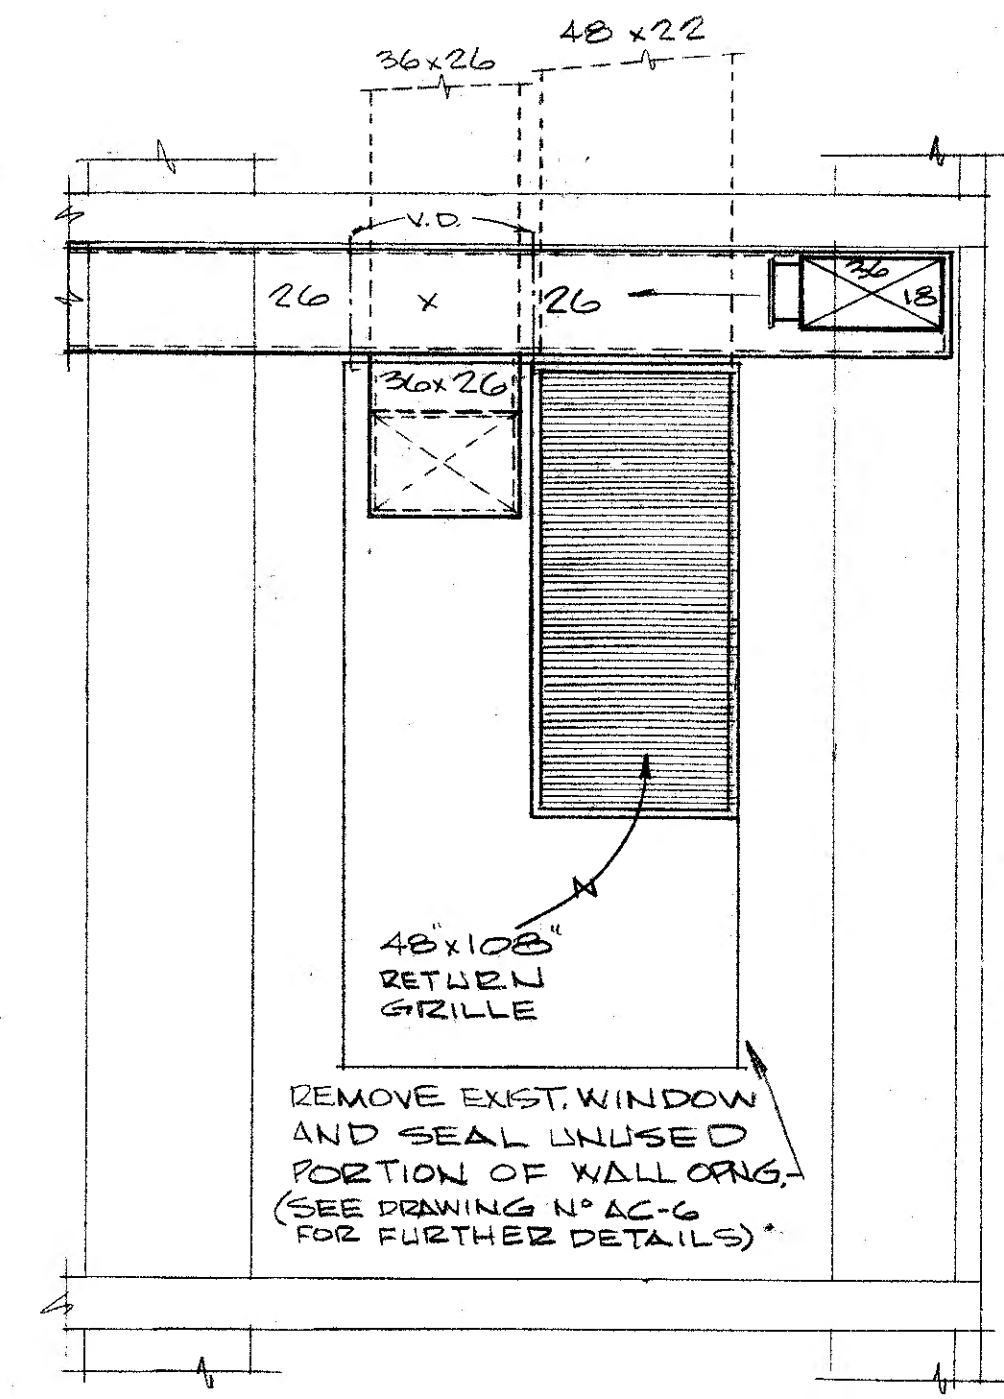

SOUND TRAP DETAIL
not to scale

TRAP NO	L	W	H	A	N° OF CELLS	CFM
1	60"	48"	22"	6"	4	14,580
2	84"	36"	26"	6"	3	16,200
3	60"	48"	28"	6"	4	15,120
4	84"	40"	20"	6"	3	16,800

REGENTAL, RUBINSTEIN, INC.
ENGINEERING CONSULTANTS
FANWOOD NEW JERSEY
LICENSE NO.

ELEVATIONS & DETAILS
RECONSTRUCTION OF THE
NEWARK, PUBLIC, LIBRARY,
MAIN, BUILDING.
5 WASHINGTON, ST, NEWARK, N. J.

REVISIONS

MICHAEL A. TROTTA,
ARCHITECT
1801 RAVINE DR, FORKED RIVER, N.J.
8017
M.
609/693-3892
CERT. NO. C-2948
4/5/82

AC4
SF
GA

EQUIPMENT SCHEDULE

ITEM	MFR.	MODEL	DESCRIPTION	ACCESSORIES	ELECT'L DATA	WEIGHT	DIMENSIONS
AHU N° 1 PHASE 1	CARRIER CORP.	40R2012	VERTICAL AIR HANDLING UNIT, 4000 CFM SUPPLY AIR, NOMINAL 10 TONS COOLING AT ARI CONDITIONS	1. THROWAWAY FILTERS 2. VARIABLE FAN DRIVE 3. FULLY SUPPORTING SPRING TYPE VIBRATION ELIMINATOR RAILS AS MFRD. BY VIBRATION ELIMINATOR CORP.	208V-3Ø-60CY 2HP FAN MTR	500 LBS	5'-2 1/2" W x 2'-1 1/8" D x 4'-3 3/8" H.
AHU N° 2,3,4,6 PHASE 1 (2,3,4) PHASE 2 (6)	CARRIER CORP.	40FS 220	VERTICAL/HORIZONTAL AIR HANDLING UNIT, 2000 CFM SUPPLY AIR, NOMINAL 5 TONS COOLING @ 8 ARI COND. COOLING COIL: 28HQ000	1. SEE PLANS FOR MOUNTING REQUIREMENTS. 2. THROWAWAY FILTERS. 3. HORIZONTAL UNITS INSTALLED WITH VIBRATION ELIMINATOR CORP. SPRING TYPE ISOLATION HANGERS.	208V-1Ø-60CY 1HP PSC MTR.	125 LBS	3'-10 3/8" L x 2'-0 1/8" W x 1'-10 1/8" D
AHU N° 5 PHASE 2	CARRIER CORP.	40FS 200	HORIZONTAL AIR HANDLING UNIT, 1500 CFM SUPPLY AIR, NOMINAL 3.5 TONS COOLING COOLING COIL: 28HQ048 @ ARI CONDITIONS	SAME AS AHU N° 2	208V-1Ø-60CY 1/2HP PSC MTR	105 LBS	3'-9 3/8" L x 1'-9 3/8" W x 1'-10 1/8" D.
AHU N° 7 PHASE 3	MCQUAY CORP.	RDS-804-B	HORIZONTAL ROOF MTD. AIR HANDLING UNIT 16,800 CFM, 4 1/2" TSP, 1432RPM, COOLING CAPACITY: 527.7 MBH, 77.5°F EDB, 64°F EWB, 50°F LDB, 55°F LWB, 47.3°F, 37.6 SQ. FT. COIL FACE AREA, 1680 CFM MIN. O.A.	1. AIR COIL SUPPLY FAN W/INLET GUIDE VANES 2. DX COOLING COIL, 6ROW, 8FINS/INCH 3. R.A. PENUM W/30% O.A. HOOD 4. THROWAWAY FILTERS, ANGULAR SECTION 5. COMPLETELY INSULATED AND WEATHERPROOFED CABINET COILING AND FRAME 6. VARIABLE FAN DRIVE 7. VIBRATION ELIMINATOR SEE SPECIFICATIONS 8. DRYER, INDUSTRIAL GRADE, FILTER PRESSURE DIFFERENTIAL SWITCH	208V-3Ø-60CY 20HP FAN MTR	4100 LBS	13'-10 L x 7'-10 W x 7'-0" H.
AHU N° 8 PHASE 2	MCQUAY CORP.	RDS-804-B	HORIZONTAL ROOF MTD. AIR HANDLING UNIT 16,200 CFM, 4 1/2" TSP, 1400 RPM, COOLING CAPACITY: 488.5 MBH, 77.5°F EDB, 64°F EWB, 50°F LDB, 55°F LWB, 47.3°F, 37.6 SQ. FT. COIL FACE AREA, 1620 CFM MIN. O.A.	SAME AS AHU N° 7 EXCEPT DX COOLING COIL - 5ROW, 8FINS/INCH	208V-3Ø-60CY 20HP FAN MTR	4100 LBS	13'-10 L x 7'-10 W x 7'-0" H.
ACCU N° 1 PHASE 1	CARRIER CORP.	38BA009	AIR COOLED CONDENSING UNIT 10 TONS COOLING @ 95°AMB. EER - 7.7	1. COOLING STAT W/FAN SWITCH 2. VIBRATION ISOLATORS, SEE SPECS. 3. 5 YEAR COMPRESSOR WARRANTY 4. INDOOR FAN RELAY 5. MOTORMASTER CONTROL 6. TIME GUARDED	208V-3Ø-60CY COMPR.: 33.6 RLA 170 LRA COND.: 3.6 FLA	600 LBS	3'-3 3/8" L x 3'-8 3/8" W x 2'-9" H.
ACCU N° 2,3,4,6 PHASE 1 (2,3,4) PHASE 2 (6)	CARRIER CORP.	38CB060	AIR COOLED CONDENSING UNIT 5 TONS COOLING @ 95°AMB, EER - 6.6	SAME AS ACCU N° 1	208V-3Ø-60CY COMPR.: 24.0 RLA COND.: 2.0 RLA	200 LBS	2'-10 1/4" L x 1'-10 W x 2'-0 3/8" H
ACCU N° 5 PHASE 2	CARRIER CORP.	38CB042	AIR COOLED CONDENSING UNIT 3.5 TONS COOLING @ 95°AMB EER - 7.0	SAME AS ACCU N° 1	208V-3Ø-60CY COMPR.: 16.6 RLA COND.: 2.0 RLA	190 LBS	2'-10 1/4" L x 1'-10 W x 2'-0 3/8" H.
ACCU N° 7 PHASE 3	MCQUAY CORP.	ALP.046A	AIR COOLED CONDENSING UNIT 527.7 MBH COOLING @ 95°AMB, 11.3 EER	SAME AS ACCU N° 1 PLUS 7. DUAL REFRIGERANT CIRCUITS 8. PART WINDING START ON COMPRESSORS 9. TIME DELAY BETWEEN COMPRESSORS N° 1 & 2 OPERATION. 10. FOUR STAGE CAPACITY REDUCTION 11. PUMP DOWN CYCLE CONTROL	208V-3Ø-60CY NAMEPLATE AMPS COMPR.#1: 64 RLA COMPR.#2: 80 RLA (4) COND. @ 5/2 RLA ea. LRA (4) COND. @ 40 LRA ea. PART WINDING START COMPR.#1: 188 LRA COMPR.#2: 250 LRA	3550 LBS	12'-4 L x 6'-3 3/8 W x 5'-6" H.
ACCU N° 8 PHASE 2	MCQUAY CORP.	ALP.046A	AIR COOLED CONDENSING UNIT 488.5 MBH COOLING @ 95°AMB, 11.3 EER	SAME AS ACCU N° 7	208V-3Ø-60CY NAMEPLATE AMPS COMPR.#1: 64 RLA COMPR.#2: 80 RLA (4) COND. @ 5/2 RLA ea. LRA (4) COND. @ 40 LRA ea. PART WINDING START COMPR.#1: 188 LRA COMPR.#2: 250 LRA	3550 LBS	12'-4 L x 6'-3 3/8 W x 5'-6" H.

EQUIPMENT SCHEDULE (contd.)

ITEM	MFR.	MODEL	DESCRIPTION	ACCESSORIES	ELECT'L DATA	WEIGHT	DIMENSIONS
ATU N° 1 thru 10 PHASE 2 (4 thru 10) PHASE 3 (1,2,3)	MCQUAY CORP.	CHF-008A	AIR TRANSFER UNIT, 800 CFM @ 0" SP. (FAN COIL UNIT TO BE USED AS FAN ONLY)	1. PERMANENT SPLIT CAPACITOR MOTOR 2. SOLID STATE SPEED CONTROL 3. VIBRATION ISOLATOR PADS, SEE PLANS FOR INSTALLATION REQUIREMENTS.	115V-1Ø-60CY 1/4HP PSC MOTOR		62" L x 25" W x 9" H.
2-1 PHASE 2	TEMPMASTER CORP.	TYPE S SIZE 6000	LOW PRESSURE V.A.V. UNIT, 6000 CFM @ .26" STATIC PRESS. (WIDE OPEN), 27 NC @ MIN. ACTUAL-6000 CFM	1. MODEL TR 24V DAMPER OPERATOR 2. ROOM T-STAT. 3. MANUAL INLET DAMPER W/LOCKING QUADREANT	24V.	122 LBS	36" L x 36" W x 18" H 20" OVAL INLET
2-2 PHASE 2	TEMPMASTER CORP.	TYPE S SIZE 4000	LOW PRESSURE V.A.V. UNIT, 4000 CFM @ .19" STATIC PRESSURE (WIDE OPEN), 22 NC @ MIN. ACTUAL-4000 CFM	SAME AS #2-1	24V	72 LBS	36" L x 27" W x 18" H 18" OVAL INLET
2-3 2-4 PHASE 2	TEMPMASTER CORP.	TYPE S SIZE 2000	LOW PRESSURE V.A.V. UNIT, 2000 CFM @ .18" STATIC PRESSURE (WIDE OPEN), 19 NC @ MIN. ACTUAL-2000 CFM	SAME AS #2-1	24V.	34 LBS	24" L x 27" W x 10" H. 14" OVAL INLET
2-5 PHASE 2	TEMPMASTER CORP.	TYPE S SIZE 2000	LOW PRESSURE V.A.V. UNIT, 2000 CFM @ .18" STATIC PRESSURE (WIDE OPEN), 19 NC @ MIN. ACTUAL-2000 CFM	SAME AS #2-1	24V.	34 LBS	24" L x 27" W x 10" H 14" OVAL INLET
3-1 3-2 PHASE 3	TEMPMASTER CORP.	TYPE S SIZE 6000	LOW PRESSURE V.A.V. UNIT, 6000 CFM @ .26" STATIC PRESSURE (WIDE OPEN), 27 NC @ MIN. ACTUAL-6000 CFM	SAME AS #2-1	24V.	122 LBS	36" L x 36" W x 18" H 20" OVAL INLET
3-3 3-4 PHASE 3	TEMPMASTER CORP.	TYPE S SIZE 1600	LOW PRESSURE V.A.V. UNIT, 1600 CFM @ .15" STATIC PRESSURE (WIDE OPEN), 20 NC @ MIN. ACTUAL-1600 CFM	SAME AS #2-1	24V.	28 LBS	24" L x 22" W x 10" H 12" OVAL INLET
3-5 PHASE 3	TEMPMASTER CORP.	TYPE S SIZE 2000	LOW PRESSURE V.A.V. UNIT, 2000 CFM @ .18" STATIC PRESSURE (WIDE OPEN), 19 NC @ MIN. ACTUAL-1800 CFM	SAME AS #2-1	24V.	34 LBS	24" L x 27" W x 10" H. 14" OVAL INLET

EQUIPMENT SCHEDULE


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REVISIONS

MICHAEL A. TROTTA
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SHEETMETAL DUCT SUPPORT DETAILS


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NO STIFFENERS REQUIRED IF FOLLOWING GAUGES ARE ADHERED TO:

ROUND DUCT	GAUGE	RECTANGULAR DUCT	GAUGE
3" - 8"	30	UP TO 12"	28
9" - 14"	26	13" - 14"	24
15" - 26"	24	15" - 18"	22
27" - 36"	22	19" - 20"	20
37" - 50"	20	21" - 26"	18
51" - 60"	18	27" - 30"	16


SHEETMETAL CONSTRUCTION GAUGES
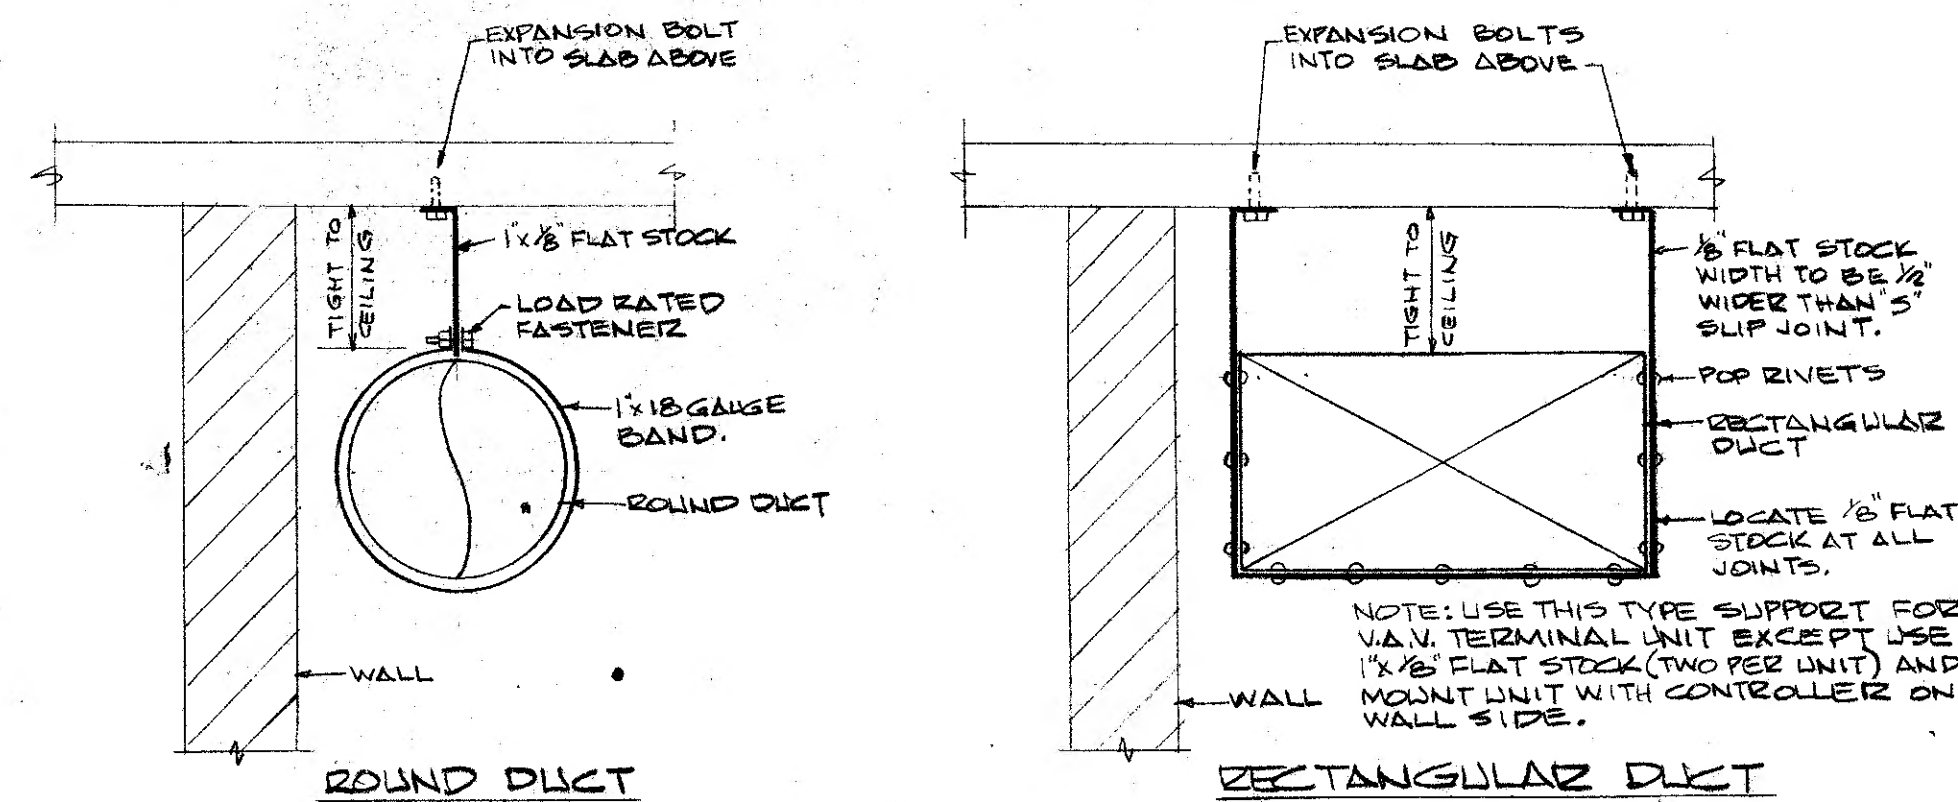
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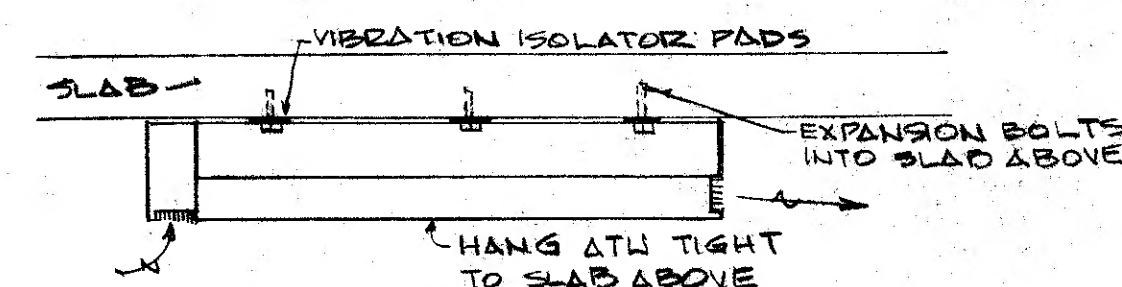
SHEETMETAL SEAM CONSTRUCTION DETAILS

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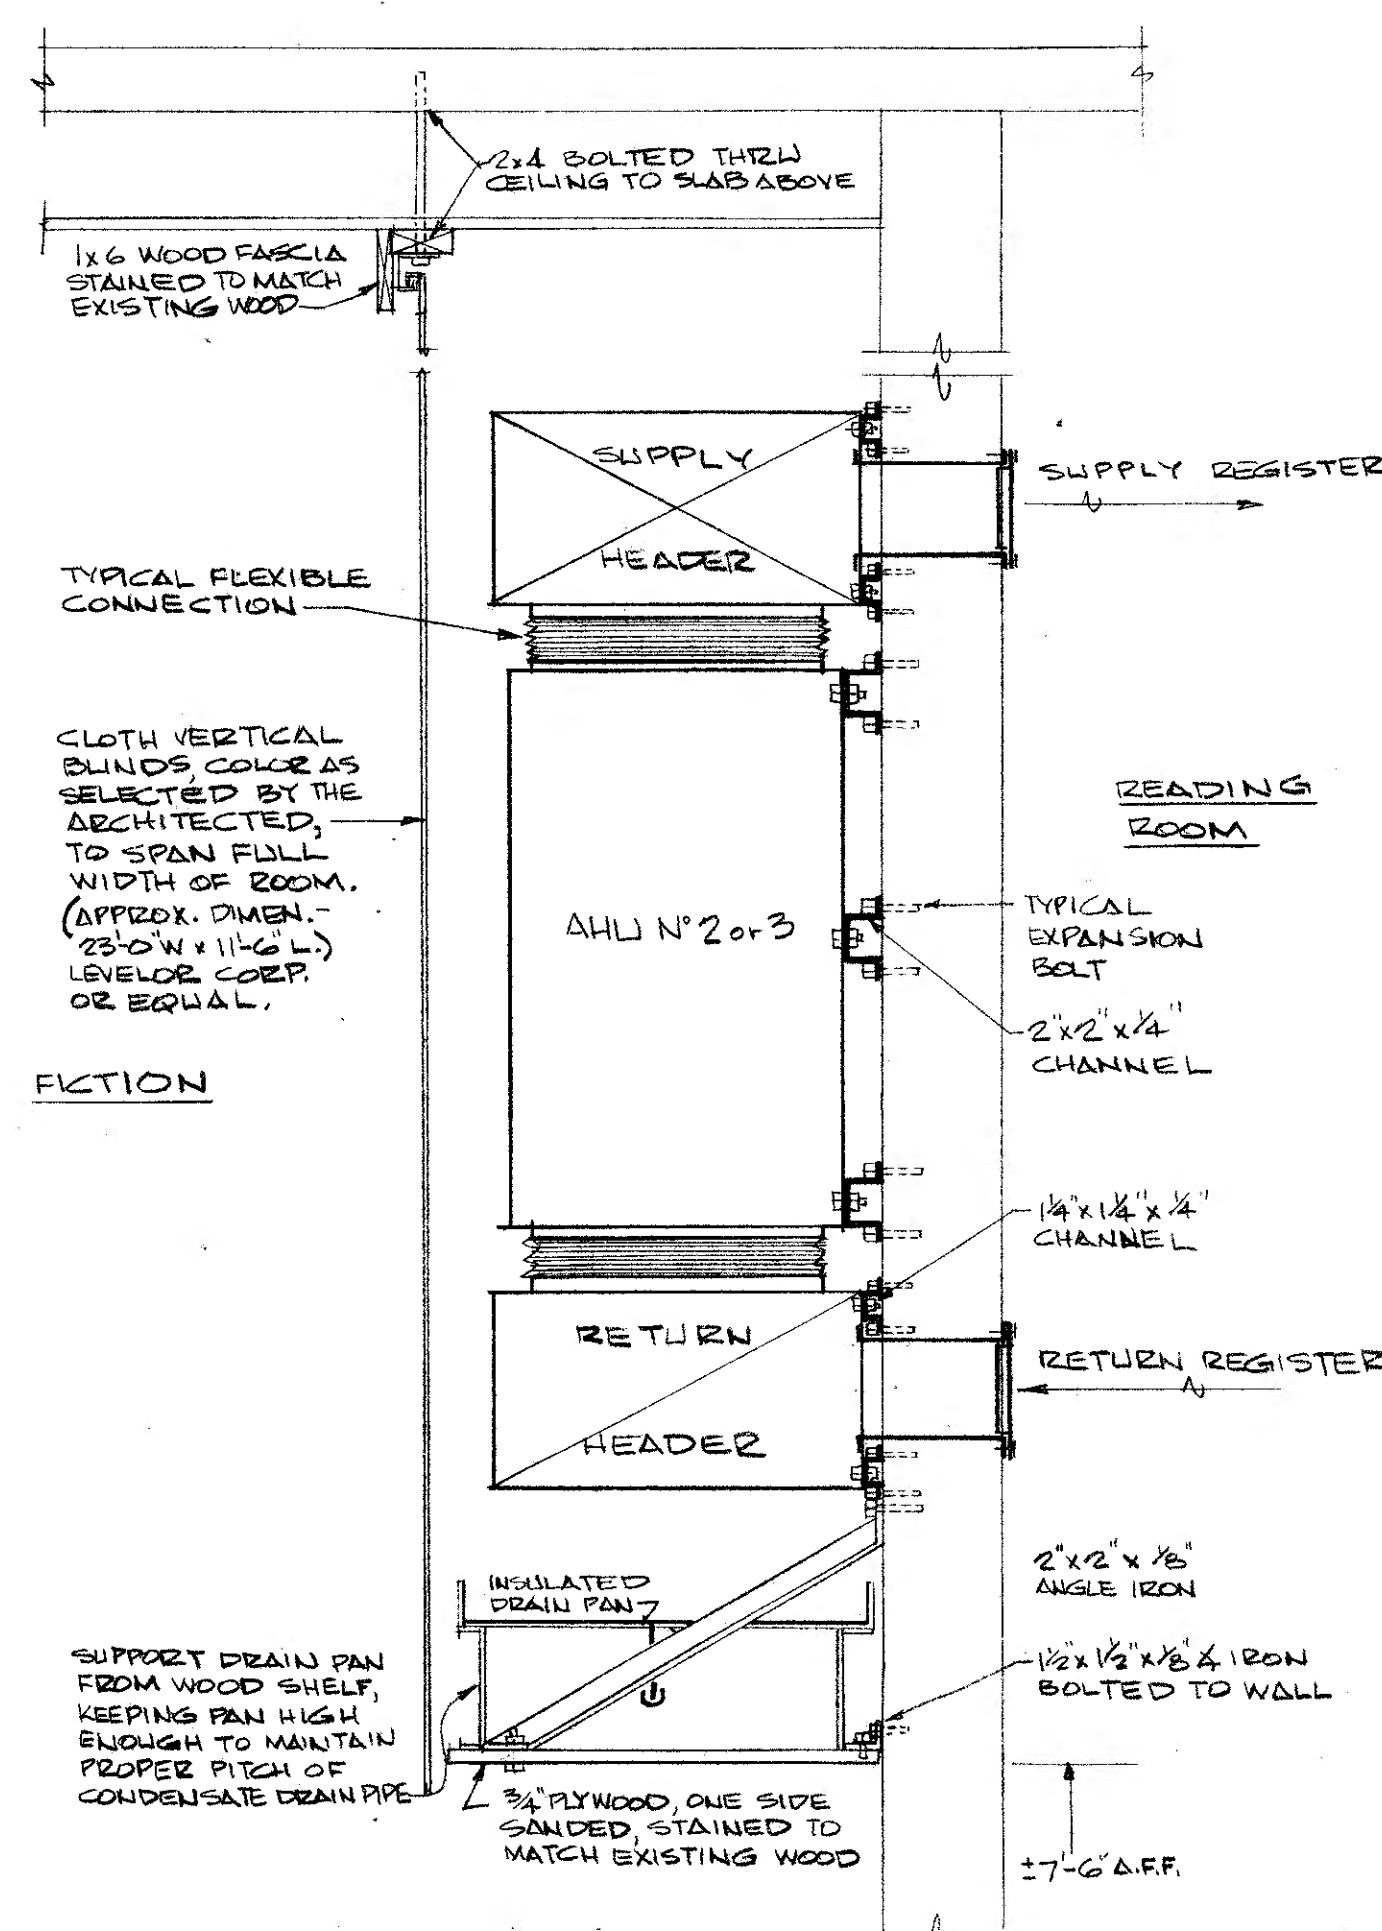
INSTALLATION DETAIL of ROOF MOUNTED DUCTS
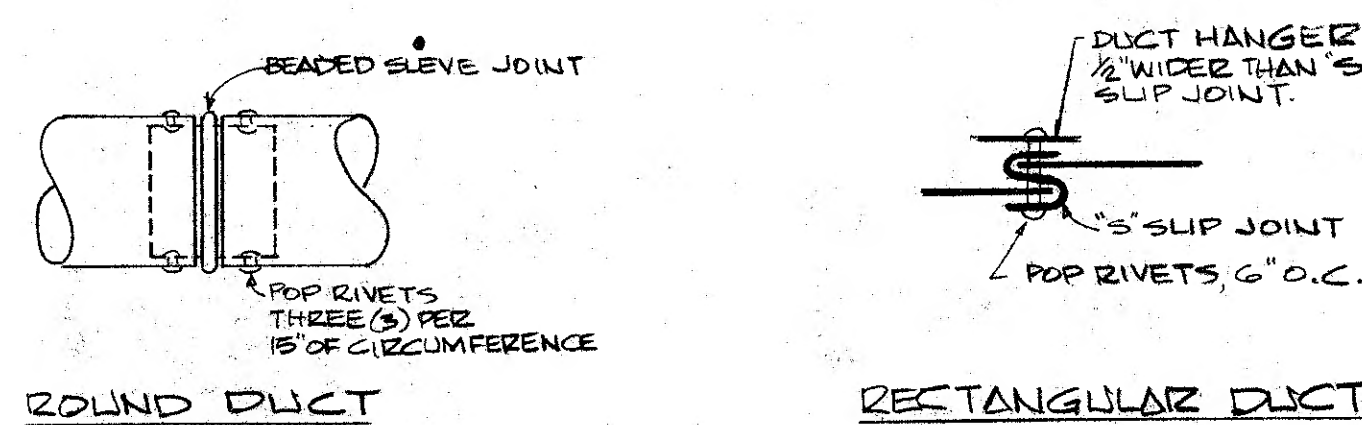
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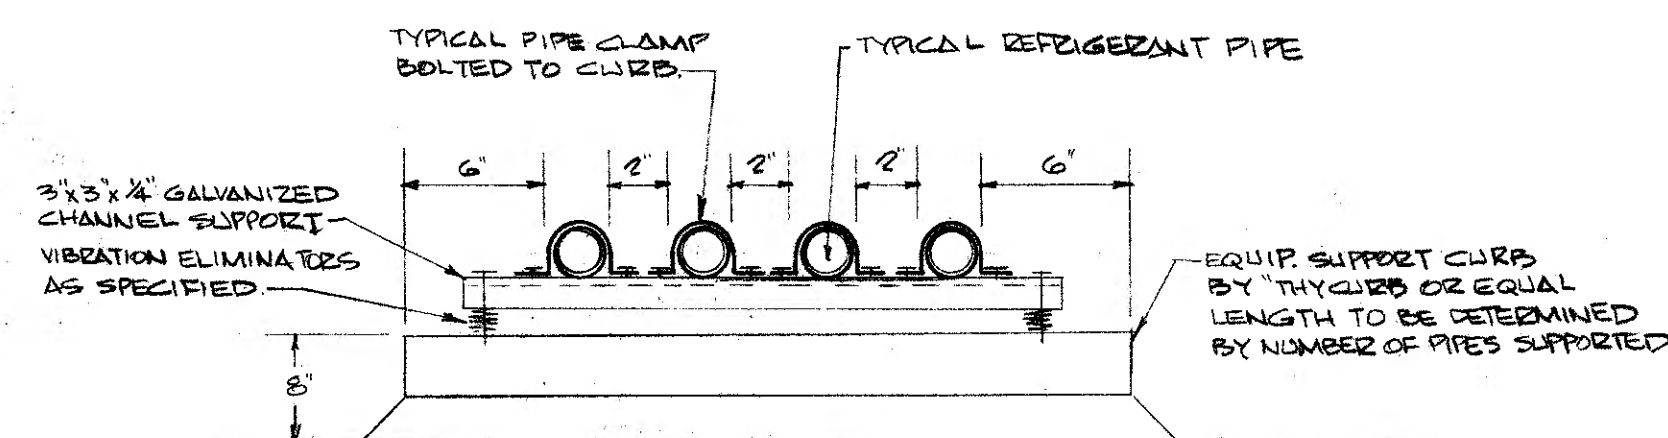
TYPICAL INSTALLATION DETAIL of A.T.U.s

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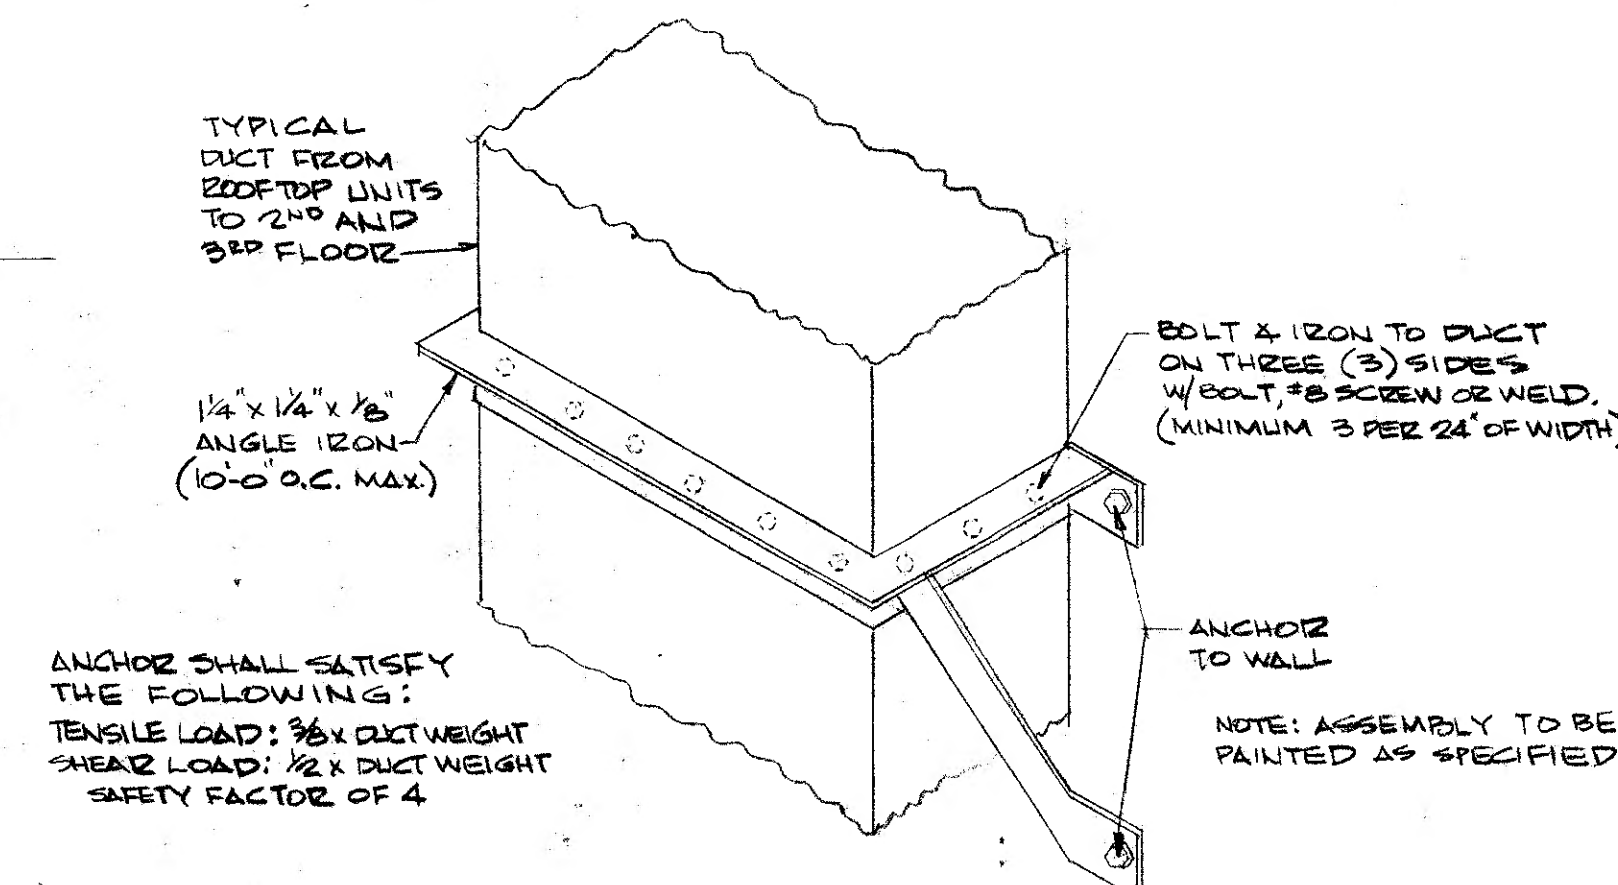
TYPICAL INSTALLATION DETAIL for AHU N°2 and 3
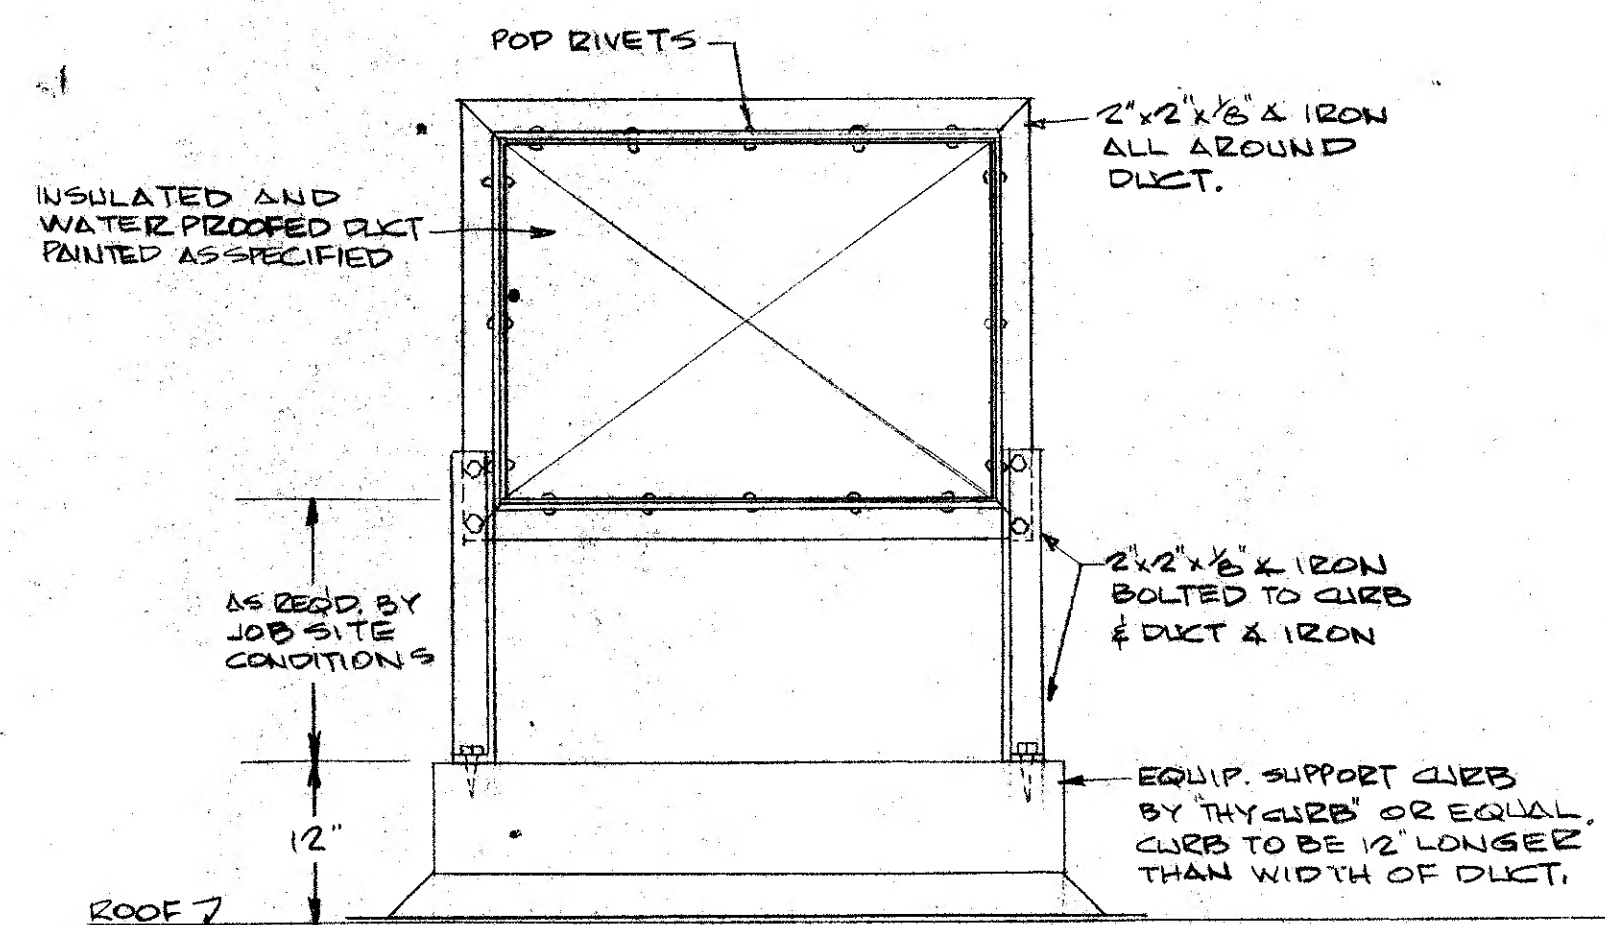
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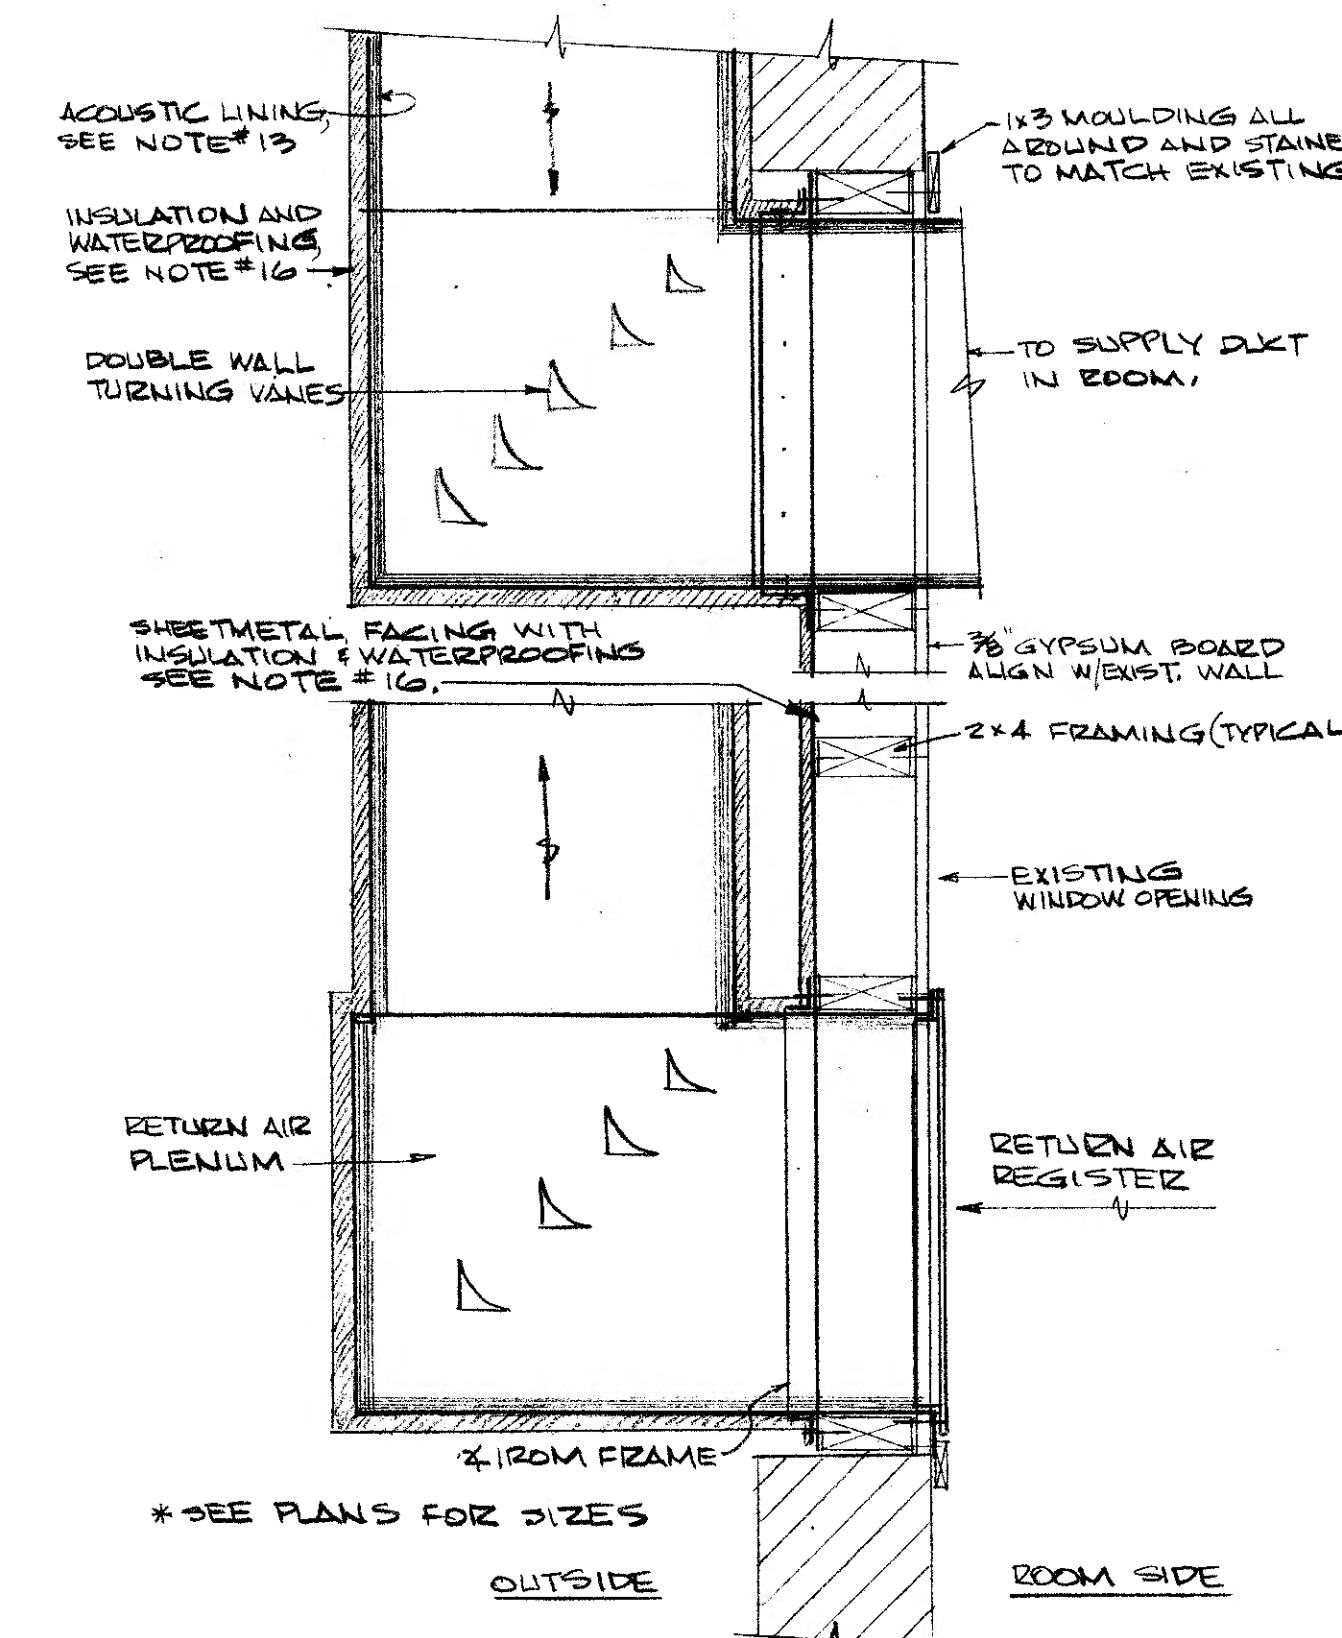
INSTALLATION DETAIL of ROOF MOUNTED REFRIGERANT PIPING

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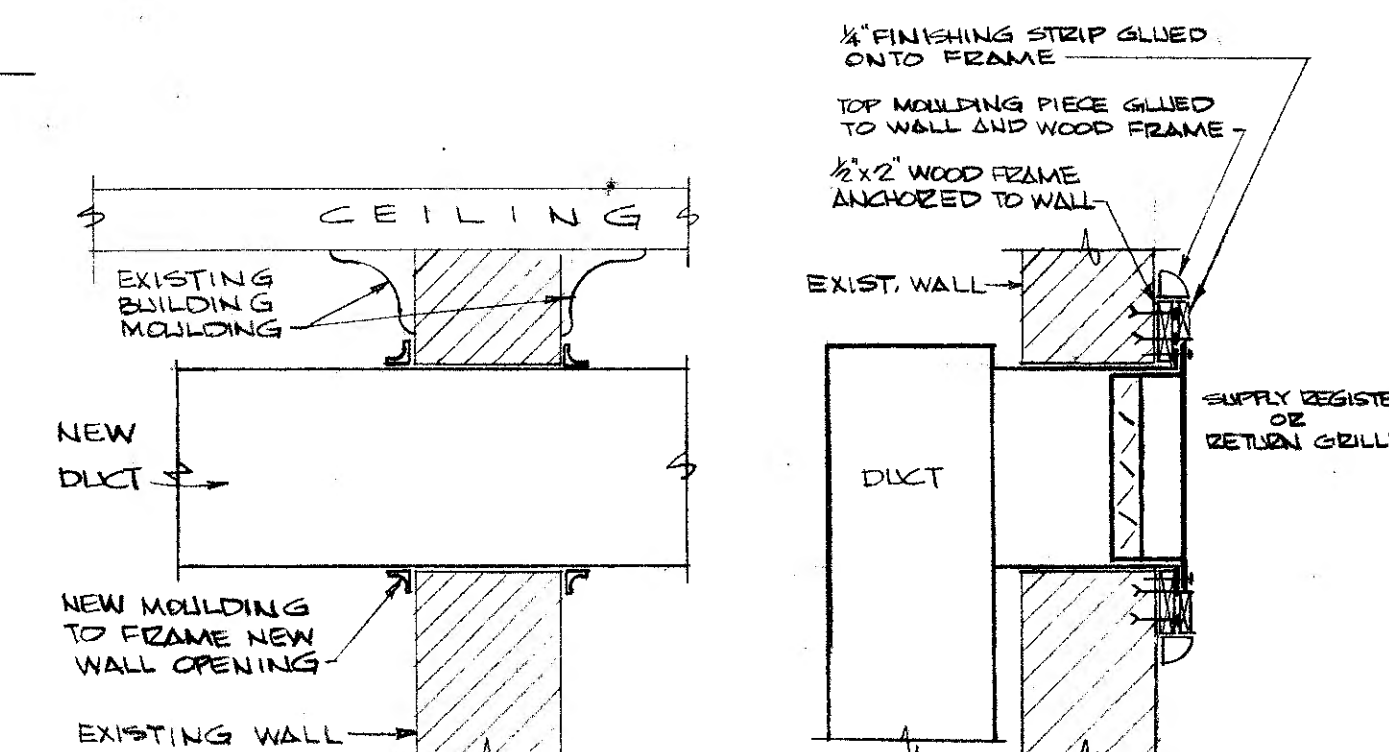
TYPICAL INSTALLATION DETAIL of DUCT RISER from ROOF DOWN on OUTSIDE of BUILDING WALL

not to scale



TYPICAL INSTALLATION DETAIL of ROOFTOP UNIT DUCTS THRU EXISTING WALL OPENINGS

not to scale



INSTALLATION NOTES

1. CUT WALL OPENING WITH 1/4\"/>

DUCT PENETRATION DETAIL OF EXISTING WALL

not to scale

GENERAL NOTES for the MECHANICAL CONTRACTOR

1. CONTRACTOR TO SUPPLY AND INSTALL ALL REQUIRED EQUIPMENT AND COMPONENTS AS SPECIFIED OR NECESSARY TO PROVIDE A COMPLETE AND SATISFACTORY JOB.
2. SHOULD THE CONTRACTORS FEEL THAT THERE ARE ANY INADVERTANT OMISSIONS AND VARIANCE WITH THE INTENT OF THIS PROJECT, HE SHALL THEN CALL IT TO THE ATTENTION OF THE ENGINEER, BEFORE PROCEEDING WITH ANY WORK.
3. CONTRACTOR TO VISIT THE JOB SITE AS A PREREQUISITE TO SUBMITTING HIS BID FOR THIS PROJECT. CONTRACTOR TO BECOME ACQUAINTED WITH SITE CONDITIONS SPECIFICALLY AS THEY APPLY TO THE INSTALLATION OF HIS PART OF THIS PROJECT. NO EXTRA PAYMENTS WILL BE MADE BY THE OWNER, TO CONTRACTOR, TO COMPENSATE FOR SITE CONDITIONS NOT SHOWN ON PLANS.
4. ALL WORK TO BE DONE IN ACCORDANCE WITH THE CODES, RULES AND REGULATIONS OF THE FOLLOWING AUTHORITIES ANY ANY OTHER AUTHORITIES HAVING JURISDICTION: N.J. STATE CODES, OWNER'S INSURANCE CARRIER, NATIONAL FIRE PROTECTION ASSOCIATION AS APPLY FOR THIS PROJECT.
5. CONTRACTOR SHALL OBTAIN AND PAY FOR ALL PERMITS AND CERTIFICATES REQUIRED FOR THE INSTALLATION OF HIS PART OF THE CONTRACT.
6. CONTRACTOR SHALL DO ALL CUTTING AND PATCHING, PROVIDE ALL SLEEVES, INSERTS, ETC., IN ACCORDANCE WITH THE REQUIREMENTS OF THE INSTALLATION OF HIS WORK.
7. CONTRACTOR TO COORDINATE HIS WORK WITH OTHER CONTRACTORS SO THERE WILL BE NO INTERFERENCES BETWEEN TRADES.
8. CONTRACTOR TO COORDINATE HIS WORK WITH OWNER SO THERE WILL BE LITTLE OR NO INTERFERENCE WITH THE NORMAL OPERATION OF THE BUILDING.
9. DURING THE PROGRESS OF WORK AND BEFORE FINAL ACCEPTANCE, CONTRACTOR IS TO PERFORM ALL REQUIRED TESTS, TO PROVIDE A DEFECT FREE INSTALLATION AND EQUIPMENT, IF REQUIRED BY THE ENGINEER, ADDITIONAL TESTS WILL BE PERFORMED AT HIS DIRECTION.
10. CONTRACTOR SHALL GUARANTEE ALL MATERIAL, WORK AND EQUIPMENT FOR A PERIOD OF ONE (1) YEAR AND AT NO ADDITIONAL EXPENSE HE SHALL TEST, ADJUST AND REPLACE ANY DEFECTIVE PART OF HIS ORIGINALLY INSTALLED SYSTEM.
11. THE DRAWINGS INDICATE THE GENERAL RUNS OF DUCTWORK, PIPES, CONDUIT AND THE LOCATION OF APPARATUS, BUT IT SHALL BE UNDERSTOOD THAT THE RIGHT IS RESERVED BY THE OWNER OR HIS REPRESENTATIVES TO CHANGE THE LOCATION OF SUCH WORK TO A REASONABLE EXTENT WITHOUT EXTRA COST TO THE OWNER.
12. ALL SHEETMETAL TO BE CONSTRUCTED AND INSTALLED IN ACCORDANCE WITH LATEST SMACNA STANDARDS FOR LOW PRESSURE DUCTWORK.
13. ALL SUPPLY AND RETURN DUCTWORK SHALL BE LINED WITH 1/2\"/>

DETAILS

RECONSTRUCTION OF THE
NEWARK PUBLIC LIBRARY
MAIN BUILDING


5 WASHINGTON ST., NEWARK, N.J.

REVISIONS

MICHAEL A. TROTTA
ARCHITECT
1801 RAVINE CR., FORKED RIVER, N.J.

8017	609/693-3392	AC/6
M.	CERT. NO. C-2548	2/6
COMM. NO.	DATE 4/5/82	SCALE AS NOTED
		DESIGN. NO.

REGENTHAL, RUBINSTEIN, INC.	INC.
ENGINEERING CONSULTANTS	
FANWOOD	NEW JERSEY
LICENSE NO.	

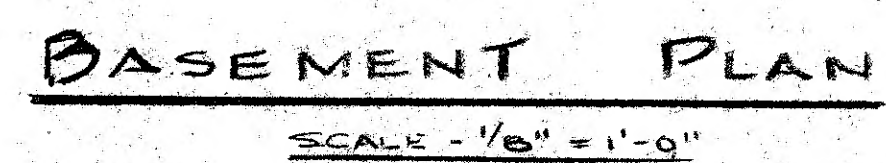

BASEMENT PLAN

SCALE - 1/8" = 1'-0"

SCALE - 1/8" = 1'-0"

RECONSTRUCTION OF THE NEWARK PUBLIC LIBRARY MAIN BUILDING

5 WASHINGTON ST, NEWARK, N.J.

REVISIONS.

MICHAEL A. TROTTA

ARCHITECT
180 RAVINE DR. FORKED RIVER, N. J.

609/693.339

8017 Michael A. Lenta

M


4/5/82 1/8 = 1.0

~~E1 7⁹⁰~~

REGENTHAL, RUBINSTEIN, INC.


ENGINEERING CONSULTANTS
FANWOOD NEW JERSEY

LICENSE NO. *Frank D. Bennett* 13766

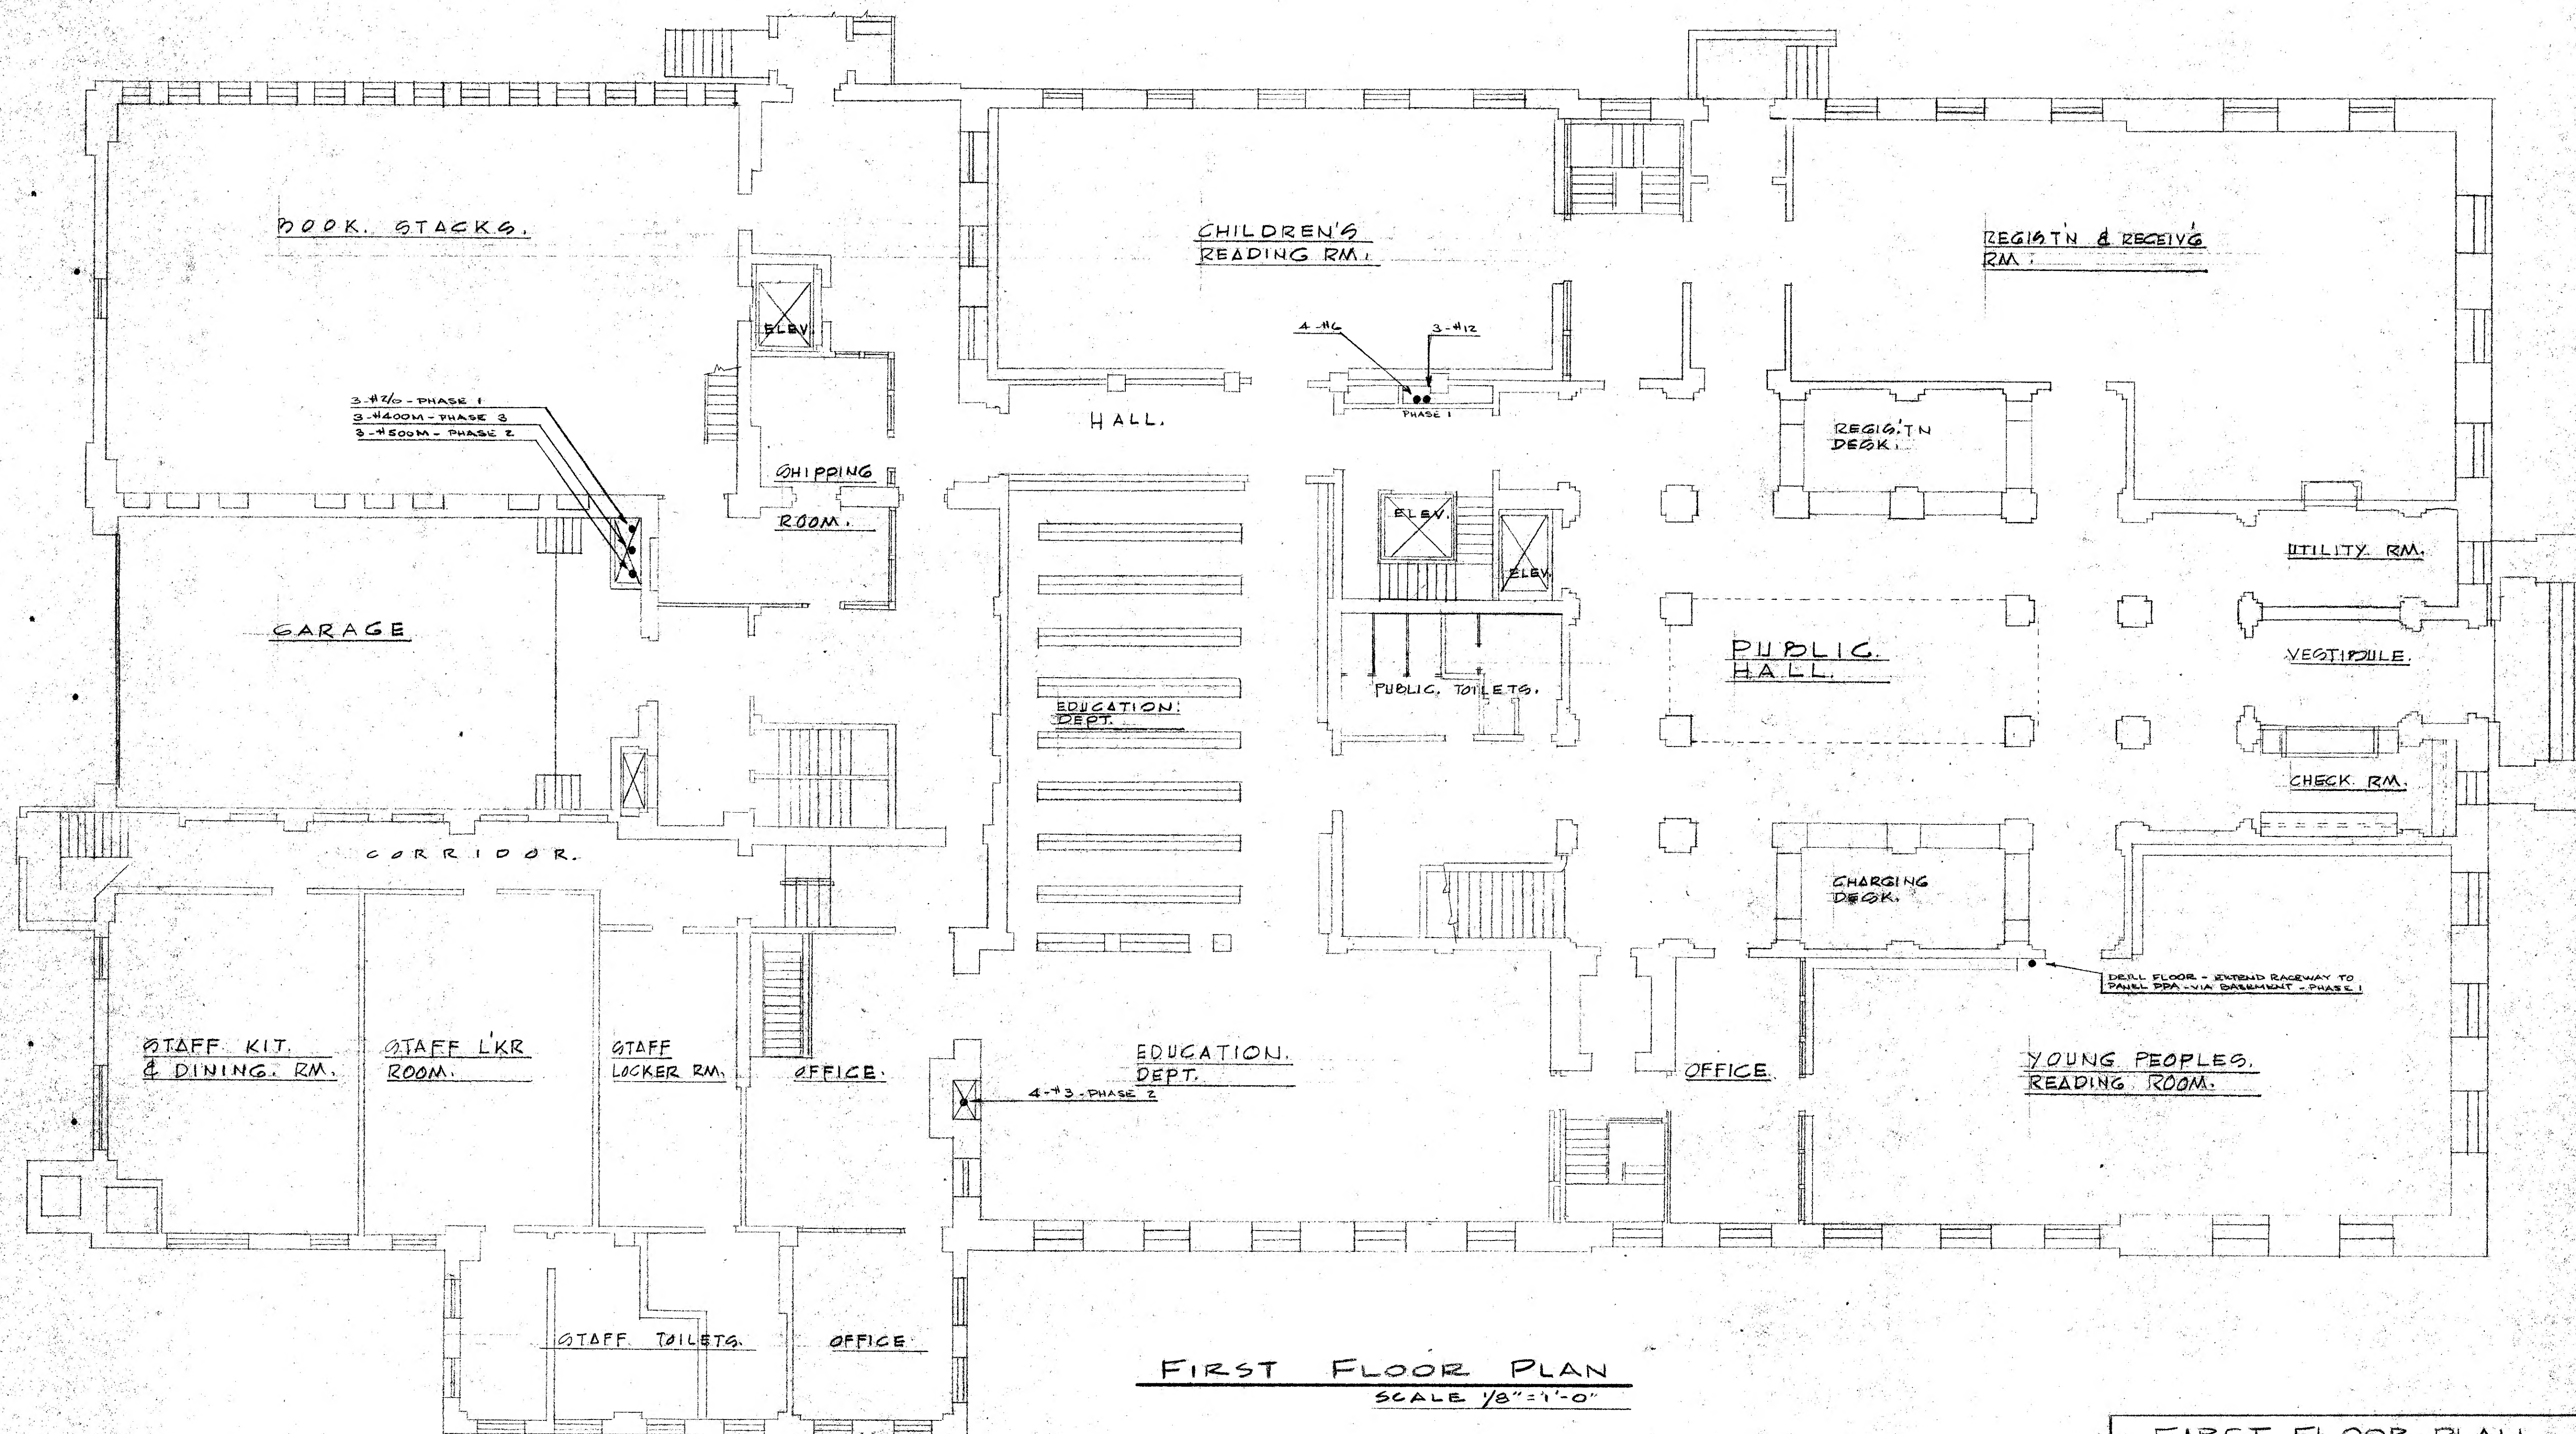


FIRST FLOOR PLAN	
RECONSTRUCTION OF THE NEWARK PUBLIC LIBRARY MAIN BUILDING	
WASHINGTON ST., NEWARK, N. J.	
REVISIONS.	MICHAEL A. TROTTA ARCHITECT 1801 RAYNE DR., FORKED RIVER, N. J. 609/692-8892
8017 M.	Michael A. Trotta CERT. NO. C-2548 4/5/82

REGENTHAL, RUBINSTEIN, INC.
ENGINEERING CONSULTANTS
FANWOOD NEW JERSEY
LICENSE NO. 13766

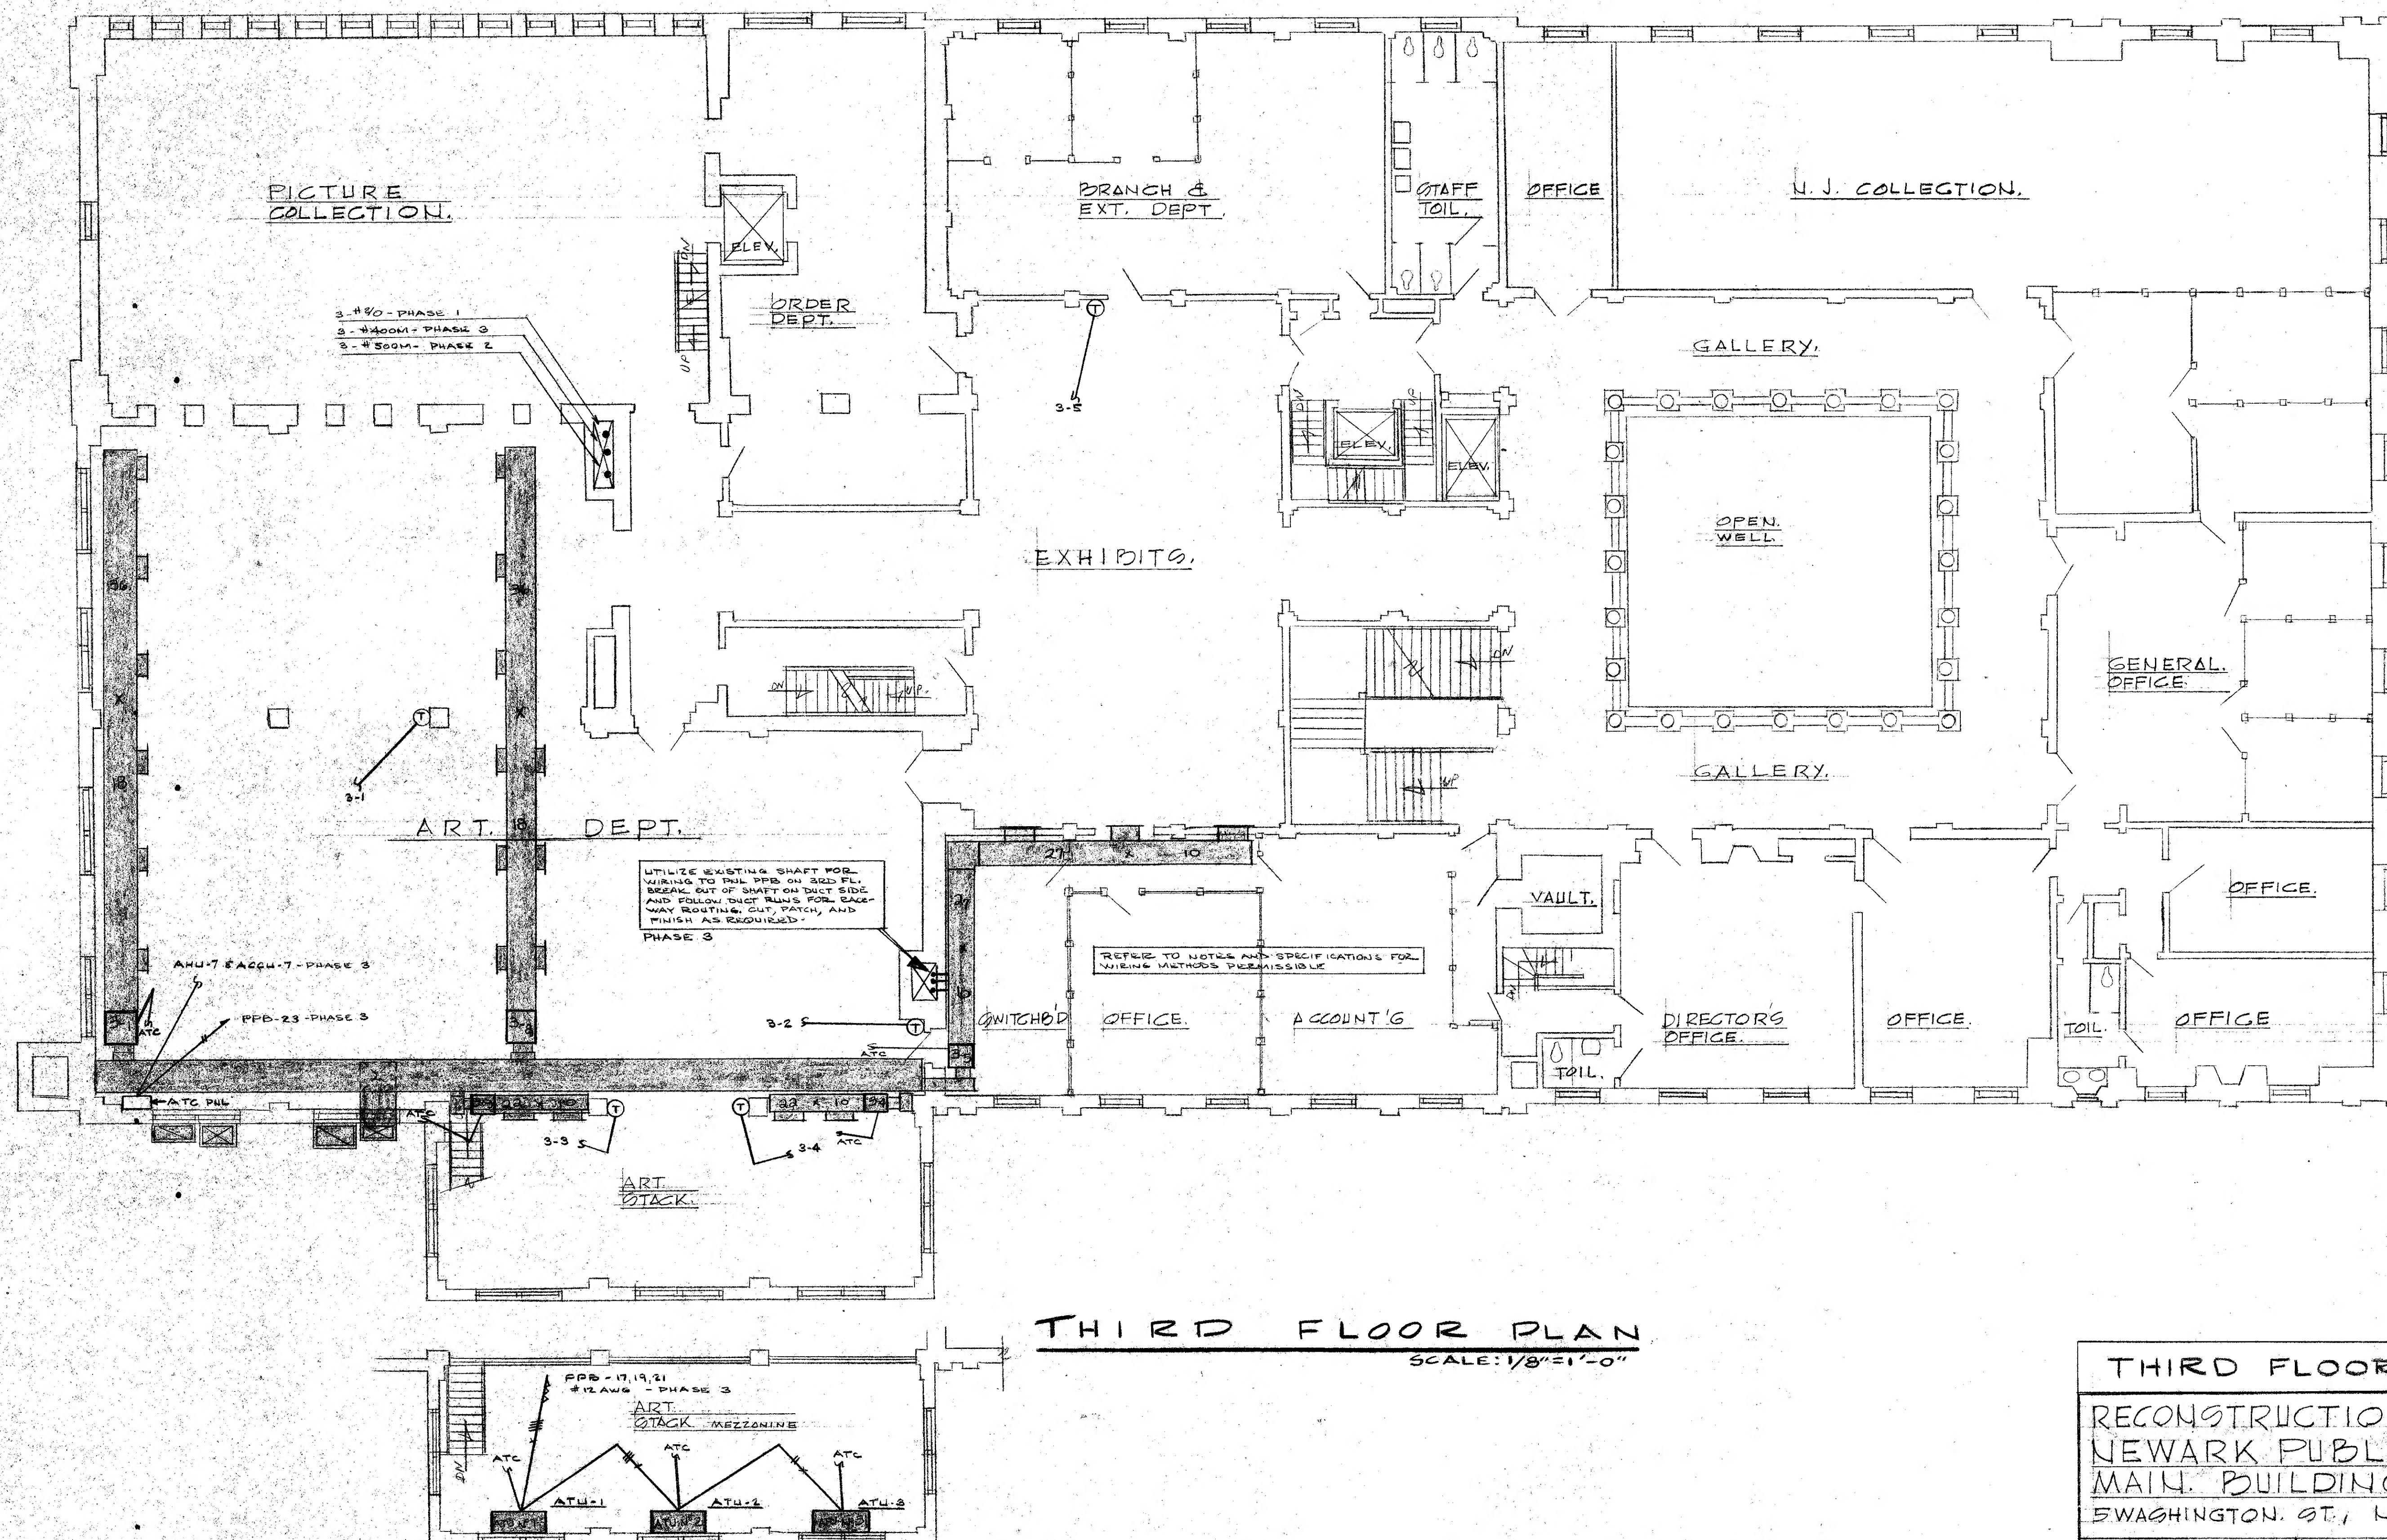

REGENTHAL, RUBINSTEIN, INC.
ENGINEERING CONSULTANTS
FANWOOD NEW JERSEY
LICENSE NO. *Frank D. Regental 13766*

THIRD FLOOR PLAN	
RECONSTRUCTION OF THE NEWARK PUBLIC LIBRARY MAIN BUILDING SWASHINGTON ST., NEWARK, N. J.	
REVISIONS.	MICHAEL A. TROTTA ARCHITECT 1801 RAVINE DR., FORKED RIVER, N. J.
8017 M.	609/693.2792 <i>Michael A. Trotta</i> CERT NO. C-2048
DATE 4/5/82	SCALE 1/8"=1'-0"

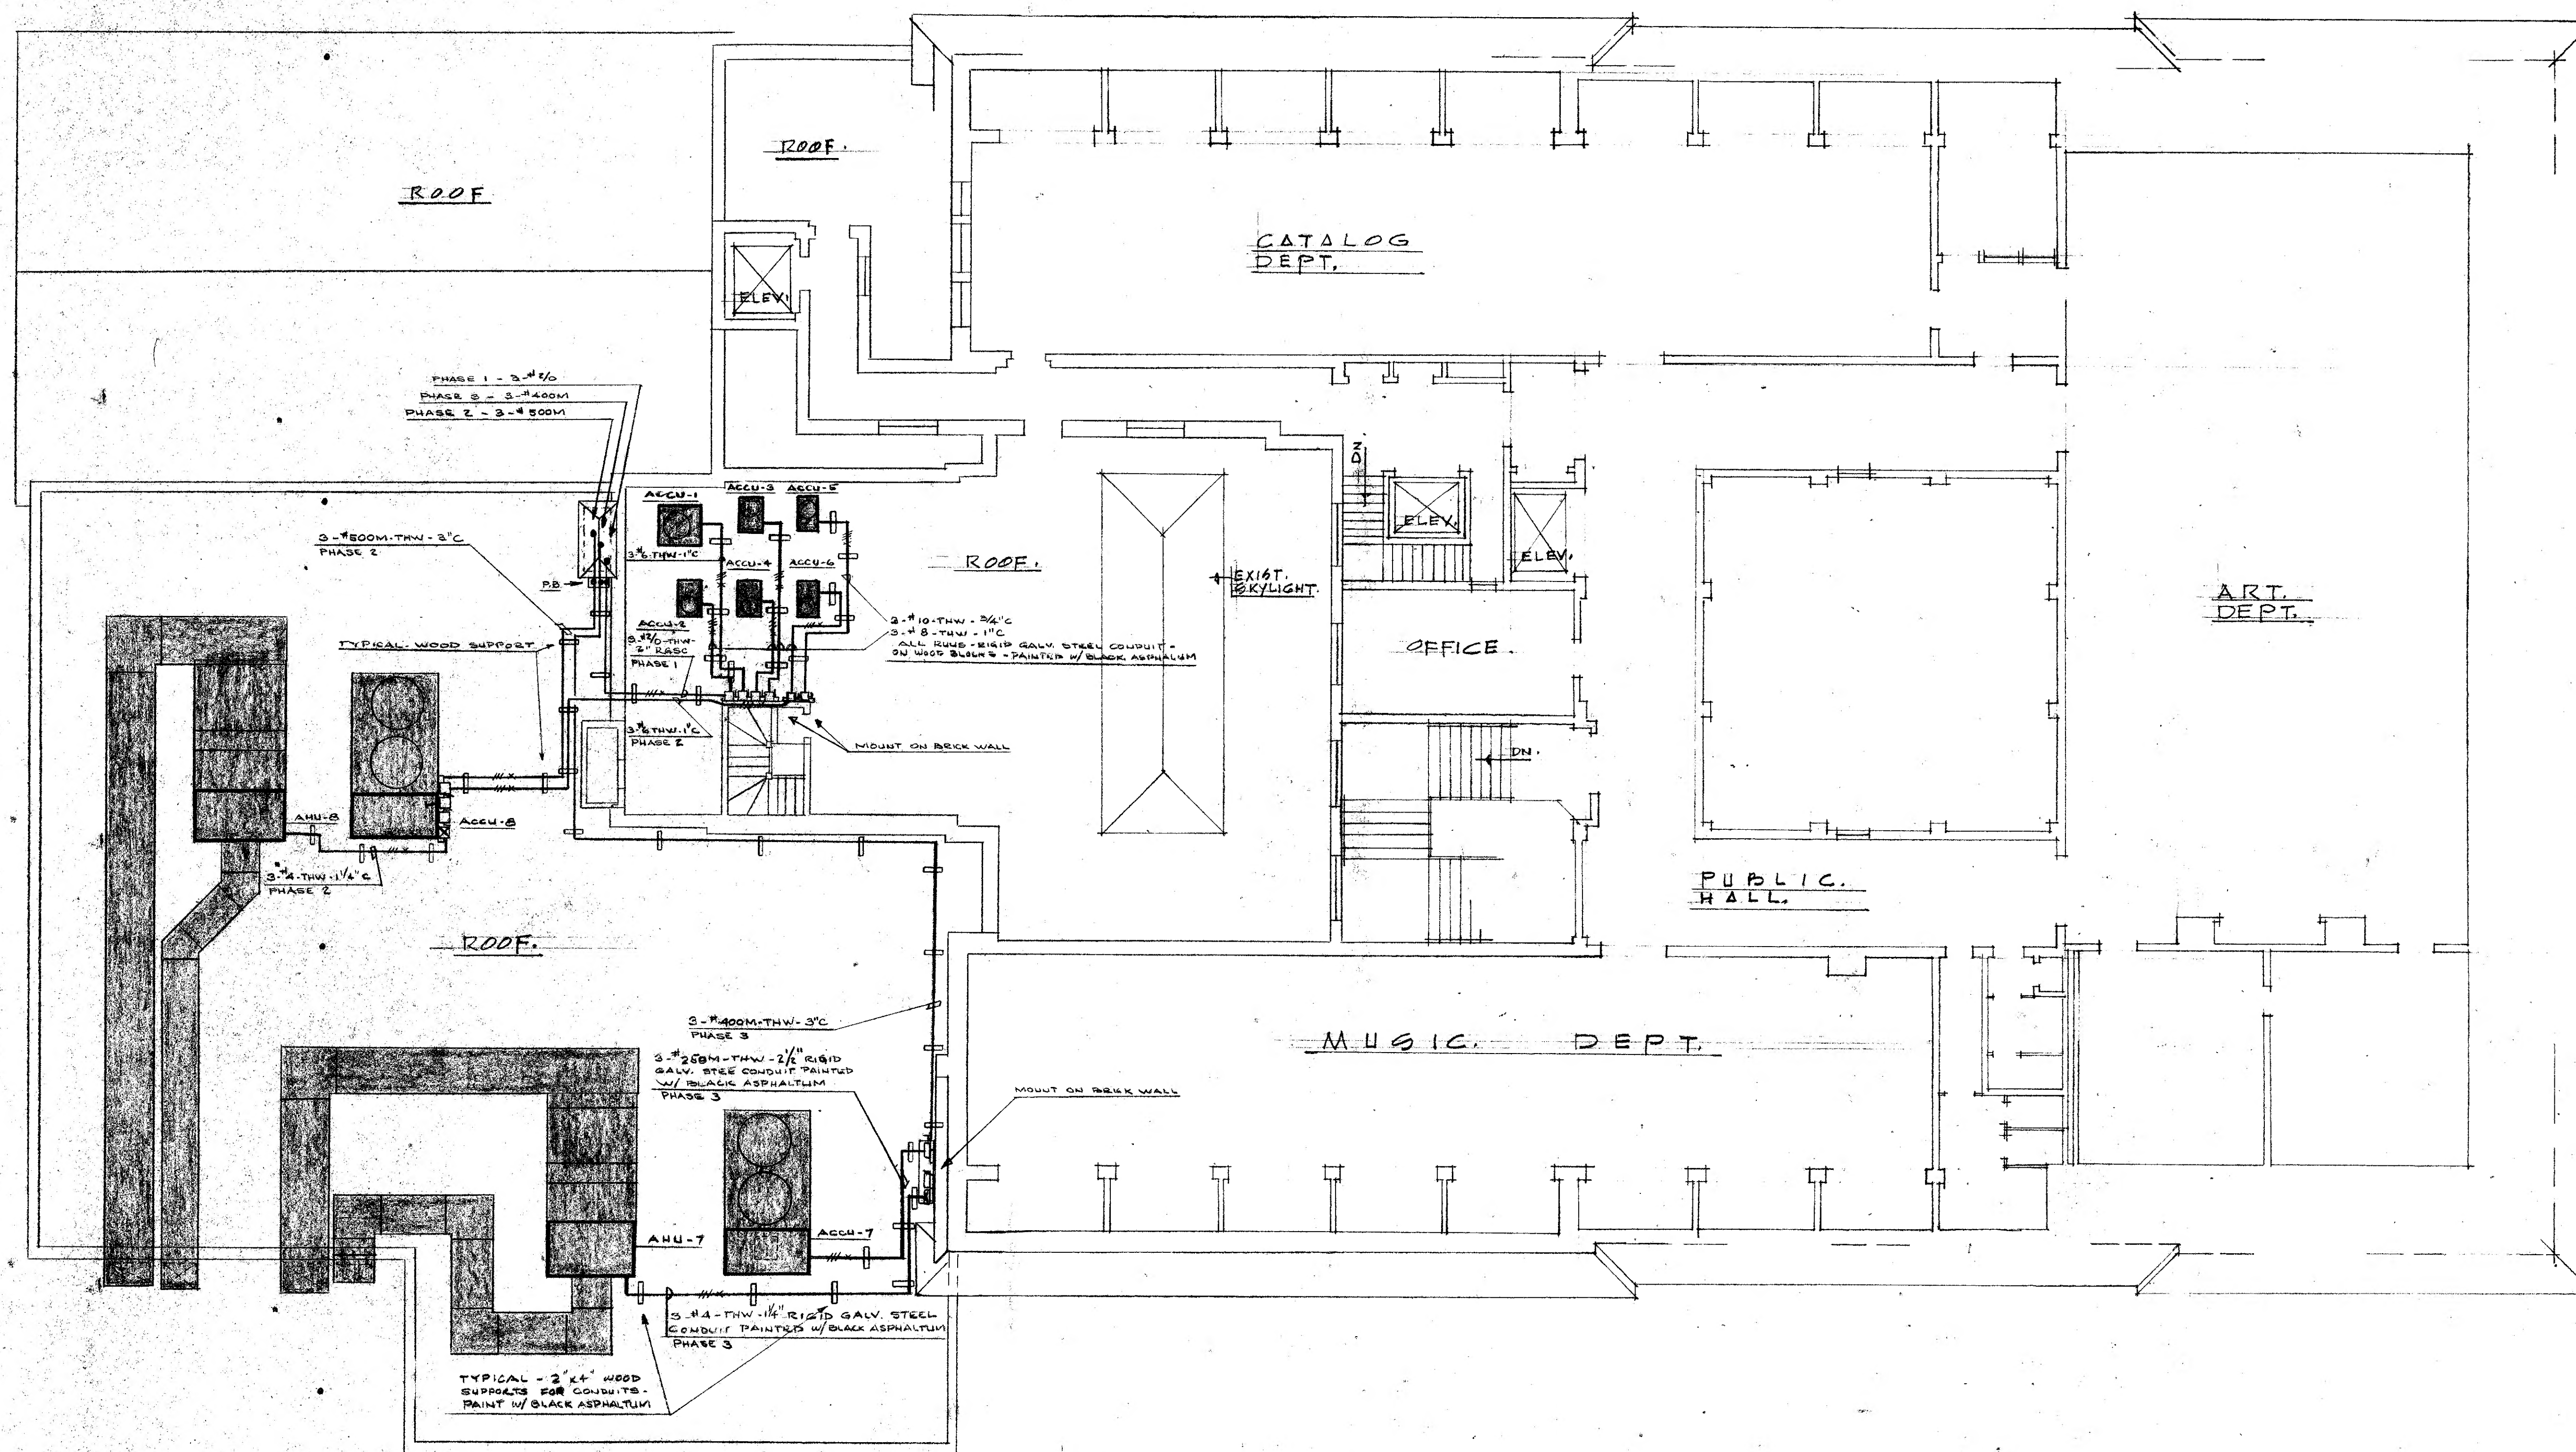

FOURTH FLOOR &
ROOF PLAN
SCALE - 1/8" = 1'-0"

FOURTH FLOOR & ROOF PLAN.
RECONSTRUCTION OF THE
NEWARK PUBLIC LIBRARY
MAIN BUILDING
5 WASHINGTON ST., NEWARK, N.J.

REVISIONS.		MICHAEL A. TROTTA ARCHITECT 1801 RAVINE DR., FORKED RIVER, N.J. 609 693-3392	
8017	4/5/82	78-21-0	E5
M.			7

REGENTHAL, RUBINSTEIN, INC.
ENGINEERING CONSULTANTS
FANWOOD NEW JERSEY
LICENSE NO. 13766

